

LOCALITY PLAN


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Olivine Estate Stage 10



16m ACCESS STREET VICINITY ROAD, METROPOLIS WAY MEDIAN GRANGE & DOWNTOWN AVENUE

			SERVICES	OFFSET SCHEDU	II F					
DOAD NAME	G	AS		ING WATER		IG WATER	ELEC	TRICITY	N	NBN
ROAD NAME	SIDE	OFFSET (m)	SIDE	OFFSET (m)	SIDE	OFFSET (m)	SIDE	OFFSET (m)	SIDE	OFFSET (m)
VICINITY ROAD	EAST	2.10	EAST	2.50	EAST	3.00	WEST	2.55	WEST	1.85
METROPOLIS WAY	SOUTH	2.10	SOUTH	2.50	SOUTH	3.00	NORTH	2.55	NORTH	1.85
MEDIAN GRANGE	EAST	2.10	EAST	2.50	EAST	3.00	WEST	2.55	WEST	1.85
DOWNTOWN AVENUE	SOUTH	2.10	SOUTH	2.50	SOUTH	3.00	NORTH	2.55	NORTH	1.85

		ROAD	LAYOUT TABLE					
ROAD NAME	RESERVE WIDTH (m)	ROAD WIDTH (m)			KERB TYPE		VERGE WIDTH (m)	
	RESERVE WIDTH (III)	LIP to LIP	INV to INV	BACK to BACK	NTH/WEST	STH/EAST	NTH/WEST	STH/EAST
VICINITY ROAD	16.00	6.40	7.30	7.60	В2	B2	4.20	4.20
METROPOLIS WAY	16.00	6.40	7.30	7.60	В2	B2	4.20	4.20
MEDIAN GRANGE	16.00	6.40	7.30	7.60	В2	B2	4.20	4.20
DOWNTOWN AVENUE	16.00	6.40	7.30	7.60	B2	В2	4.20	4.20

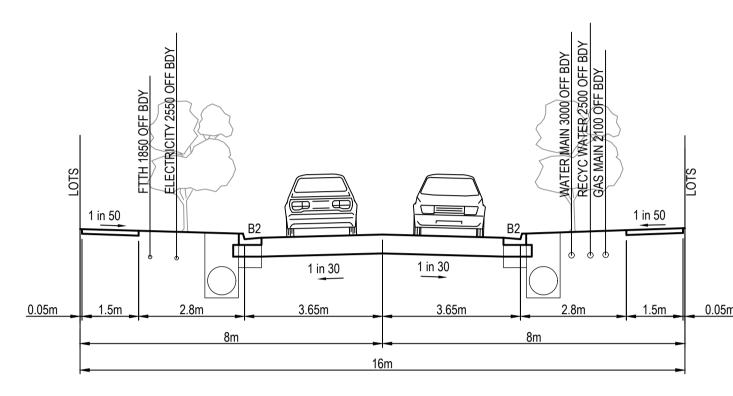			_
TYPE	VERGE W	/IDTH (m)	
STH/EAST	NTH/WEST	STH/EAST	
B2	4.20	4.20	
B2	4.20	4.20	
В2	4.20	4.20	

- CARRIED OUT TO THE SATISFACTION OF COUNCIL'S SUPERVISING OFFICER. 2. THE CONTRACTOR IS RESPONSIBLE FOR SAFETY OF WORK ON SITE IN ACCORDANCE WITH APPROPRIATE LEGISLATION. THEY SHALL ERECT AND MAINTAIN ALL SHORING, PLANKING AND STRUTTING, DEWATERING DEVICES, BARRICADES. SIGNS, LIGHTS, ETC. NECESSARY TO KEEP WORKS IN A SAFE AND STABLE CONDITION, AND TO PROTECT THE PUBLIC FROM HAZARDS ASSOCIATED WITH THE WORKS.
 - THE CONTRACTOR SHALL:

GENERAL NOTES (WHITTLESEA CITY COUNCIL)

COMPLY WITH THE SAFETY REQUIREMENTS OF THE MINES ACT, GENERAL REGULATIONS AND STATUTORY RULES, AND THE MINES (TRENCHES) REGULATIONS 1982.

THE WORKS SHALL BE CONSTRUCTED IN ACCORDANCE WITH THE VPA MANUAL AND SPECIFICATIONS. WORKS TO BE

- NOTIFY THE OCCUPATIONAL HEALTH AND SAFETY AUTHORITY OF HIS INTENTION TO COMMENCE TRENCHING OPERATIONS WHERE TRENCHES ARE 1.5 METRES OR DEEPER.
- ENSURE THAT THE MINE MANAGER OR HIS DEPUTY AS REQUIRED BY THE REGULATIONS IS IN ATTENDANCE WHEN TRENCHING OPERATIONS ARE IN PROGRESS.
- THE CONTRACTOR IS TO NOTIFY COUNCIL AND ALL SERVICE AUTHORITIES SEVEN (7) DAYS PRIOR TO COMMENCEMENT OF CONSTRUCTION. 5. THE LOCATION OF EXISTING SERVICES SHOULD BE DETERMINED BY THE CONTRACTOR PRIOR TO COMMENCING ANY
- EXCAVATION BY CONTACTING ALL RELEVENT SERVICE AUTHORITIES. ANY EXISTING SERVICES SHOWN ON THE DRAWINGS ARE OFFERED AS A GUIDE ONLY AND ARE NOT GUARANTEED AS CORRECT.
- 6. REDGUM TREES MARKED ON THE APPROVED PLANS FOR REMOVAL MUST BE REMOVED IN ACCORDANCE WITH COUNCIL'S PLANNING PERMIT. NO EXCAVATION SHALL BE CARRIED OUT WITHIN 5.0m OF ANY EXISTING TREE WITHOUT WRITTEN APPROVAL FROM COUNCIL'S SUPERVISING OFFICER.
- 7. ALL ROAD CHAINAGES ARE MEASURED ALONG THE ROAD CENTRELINE EXCEPT KERB RETURNS AND COURTHEADS, WHERE LIP OF KERB CHAINAGES ARE SPECIFIED. ALL DIMENSIONS AND RADII ARE GIVEN TO THE LIP OF KERB. DO NOT SCALE OFF THESE DRAWINGS, WRITTEN DIMENSIONS ONLY SHALL BE USED.
- 8. ALL LEVELS ARE TO AUSTRALIAN HEIGHT DATUM. 9. WHEN ENGAGED IN BLASTING OPERATIONS THE CONTRACTOR SHALL NOT BLAST WITHIN 4.5m OF AN EXISTING LINE OF WATER, GAS OR SEWER PIPES OR WITHIN 15m OF ANY COMPLETED PART OF THE WORKS WITHOUT THE CONSENT OF
- THE SUPERINTENDENT. BLASTING REQUIRES A BLASTING PERMIT FROM COUNCIL. 10. ALL EXCAVATED OR FILLED AREAS OUTSIDE THE ROAD RESERVES TO BE STRIPPED OF TOPSOIL AND STOCKPILED PRIOR TO EARTHWORKS COMMENCING. THESE AREAS SHALL BE SURFACED WITH A 100mm MINIMUM TO 200mm MAXIMUM LAYER OF TOPSOIL AS SPECIFIED.
- 11. NO TOPSOIL TO BE REMOVED FROM SITE.
- 12. NO FILL OR STOCKPILING OF MATERIAL IS TO BE PLACED ON ANY RESERVE UNLESS DIRECTED BY THE
- 13. FILLING ON ALLOTMENTS AND UNDER ROAD PAVEMENTS TO HAVE LEVEL 1 SUPERVISION IN ACCORDANCE WITH
- AS3798-1996. INDIVIDUAL LOT CERTIFICATES ARE TO BE PROVIDED TO THE SUPERINTENDENT. 14. FILLING UNDER DRIVEWAYS AND FOOTPATH IS TO BE APPROVED BY THE SUPERINTENDENT AND CONSTRUCTED IN LAYERS 150mm DEPTH. COMPACTION ACHIEVING 98% AUSTRALIAN STANDARD DENSITY.
- 15. CUT AND FILL BATTERS ARE NOT TO EXCEED 1 in 6 UNLESS SHOWN OTHERWISE.
- 16. ALLOTMENTS TO BE GRADED TO ENSURE A MINIMUM GRADE OF 1 in 150. 17. ALL DRAINAGE PIPES UP TO AND INCLUDING 750mm IN DIAMETER SHALL BE RUBBER RING JOINTED. PIPES ABOVE THIS
- SIZE MUST BE FLUSH JOINTED WITH EXTERNAL SEALING BANDS. 18. ALL DRAINAGE TRENCHES UNDER ROAD PAVEMENTS, KERB & CHANNEL, PARKING BAYS, DRIVEWAYS, FOOTPATHS AND
- BEHIND KERBS & CHANNEL SHALL BE BACKFILLED WITH CRUSHED ROCK AS SPECIFIED.
- 19. ALL PITS GREATER THAN OR EQUAL TO 900mm DEPTH TO BE PROVIDED WITH STEP IRONS IN ACCORDANCE WITH SD1041 AND COUNCIL STANDARD DRAWING EDCM 609 20. PROPERTY INLETS AS PER WHITTLESEA CITY COUNCIL STANDARD DRAWING EDCM 701-704 AND ARE TO BE LOCATED
- 1.0m FROM LOW SIDE BOUNDARY UNLESS SHOWN OTHERWISE. 21. ALL HOUSE DRAIN CONNECTIONS ARE TO BE LOCATED NO CLOSER THAN 7.0m FROM THE SIDE BOUNDARY OR FROM
- EASEMENT ALONG THE SIDE BOUNDARY UNLESS NOTED OTHERWISE AND CONNECTED DIRECTLY TO UNDERGROUND DRAIN OR PIT. HOUSE DRAIN LOCATION TO BE MARKED (50mm STAMPED IMPRESSION) ON THE TOP OF THE KERB.
- 22. SUBSOIL DRAINS SHALL BE INSTALLED BEHIND OR BELOW ALL KERB AND CHANNEL AS PER STANDARD DRAWING EDCM
- 23. CONDUIT LOCATIONS ARE SUBJECT TO AMENDMENT AND CONDUITS SHALL NOT BE LAID UNTIL WRITTEN APPROVAL IS GIVEN BY THE SUPERINTENDENT. CONDUITS TO BE EXTENDED TO PROPERTY LINE AND ARE REQUIRED WHEN CONNECTIONS EXTEND UNDER ROAD PAVEMENT, FOOTPATH OR OTHER INFRASTRUCTURE. BOTH KERBS ARE TO BE MARKED WITH THE LETTERS H (PROPERTY STORMWATER CONNECTION), E (ELECTRICAL), G (GAS), T (TELEPHONE), W (WATER) AND C (COUNCIL COMMUNICATION) AS PER STANDARD DRAWING EDCM 303.
- 24. ALL SERVICING TRENCHES UNDER ROADS, DRIVEWAYS, FOOTPATHS ETC. ARE TO BE BACKFILLED & COMPACTED WITH F.C.R. IN THE CASE OF TRENCHES UNDER ROADS WHERE BACKFILLING HAS NOT ACHIEVED THE SPECIFIED COMPACTION OR SHOWS EXCESSIVE MOVEMENT UNDER PROFFROLLING, THE BACKFILLING SHALL BE REMOVED AND REPLACED WITH 2% STABILISED COMPACTED F.C.R. ALL SERVICES ARE TO BE PLACED PRIOR TO THE CAPPING LAYER.
- 25. NO TELSTRA PITS ARE TO BE LOCATED IN THE FOOTPATH. 26. VEHICULAR CROSSINGS TO BE LOCATED CLEAR OF DRAINAGE PITS, SEWER MAINTENANCE HOLES AND EXISTING TREES. VEHICLE CROSSINGS TO BE 1.5m FROM PROPERTY BOUNDARY OR EASEMENT UNLESS OTHERWISE SHOWN. VEHICULAR CROSSINGS TO BE CONSTRUCTED AS PER WHITTLESEA CITY COUNCIL'S SPECIFICATIONS AND EDCM 501
- 27. ALL PEDESTRIAN CROSSING THROUGH SPLITTER ISLANDS TO BE IN ACCORDANCE WITH SD606.
- 28. ALL STREET SIGNS TO BE IN ACCORDANCE WITH SD812. STREET SIGNS TO BE ATTACHED TO LIGHT POLES USING
- 'SINGLE DIRECTION COLLAR' OR '90° RIGHT ANGLE COLLAR' UNLESS SHOWN OTHERWISE. 29. ALL PAVEMENT MARKINGS AND TRAFFIC SIGNS SHOULD BE TO AS1742.2 AND AS1742.1 STANDARD RESPECTIVELY. TEMPORARY LINEMARKING TO BE PLACED DURING MAINTENANCE PERIOD PRIOR TO PLACEMENT OF WEARING COURSE. FINAL LINEMARKING TO BE LONG LIFE ROAD MARKING WITH LONGITUDINAL LINES IN THERMOPLASTIC AND TRANSVERSE MARKINGS IN COLD APPLIED.
- 30. THE CAPPING LAYER MUST BE DEMONSTRATED THROUGH TESTING THAT ITS PROPERTIES (CBR. PERMEABILITY, ETC.) SATISFY LIMITS AS OUTLINED IN THE TECHNICAL SPECIFICATION TABLE 20.3.5B WITH A MINIMUM MODULAS OF 100MPa
- 31. UPON COMPLETION OF CONSTRUCTION THE WHOLE SITE SHALL BE CLEANED UP, GRADED, ALL RUBBISH REMOVED
- AND LEFT IN A CLEAN AND TIDY CONDITION TO THE SATISFACTION OF THE SUPERINTENDENT. 32. ALL FOOTPATHS & SHARED PATHS ARE TO BE CONSTRUCTED IN ACCORDANCE WITH EDCM 401.

WARNING

SAFETY MEASURES REQUIRED

Please note there are risks attached to the construction of this project, and any ongoing maintenance of structures. Consider the safety of all. For potential risks, consequence and controls refer to Safety In Design Risk Register SID P4.E6. 1700E-05A-01

ASSESS THE RISK - STAY SAFE

WARNING BEWARE OF UNDERGROUND SERVICES

The locations of underground services are approximate only and their exact position should be proven on site. No guarantee is given that all existing services are shown. Locate all underground services before commencement of works **DIAL 1100 BEFORE YOU DIG**

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AMENDMENT / REVISION DESCRIPTION

28.05.19 ISSUED TO COUNCIL FOR APPROVAL









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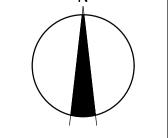
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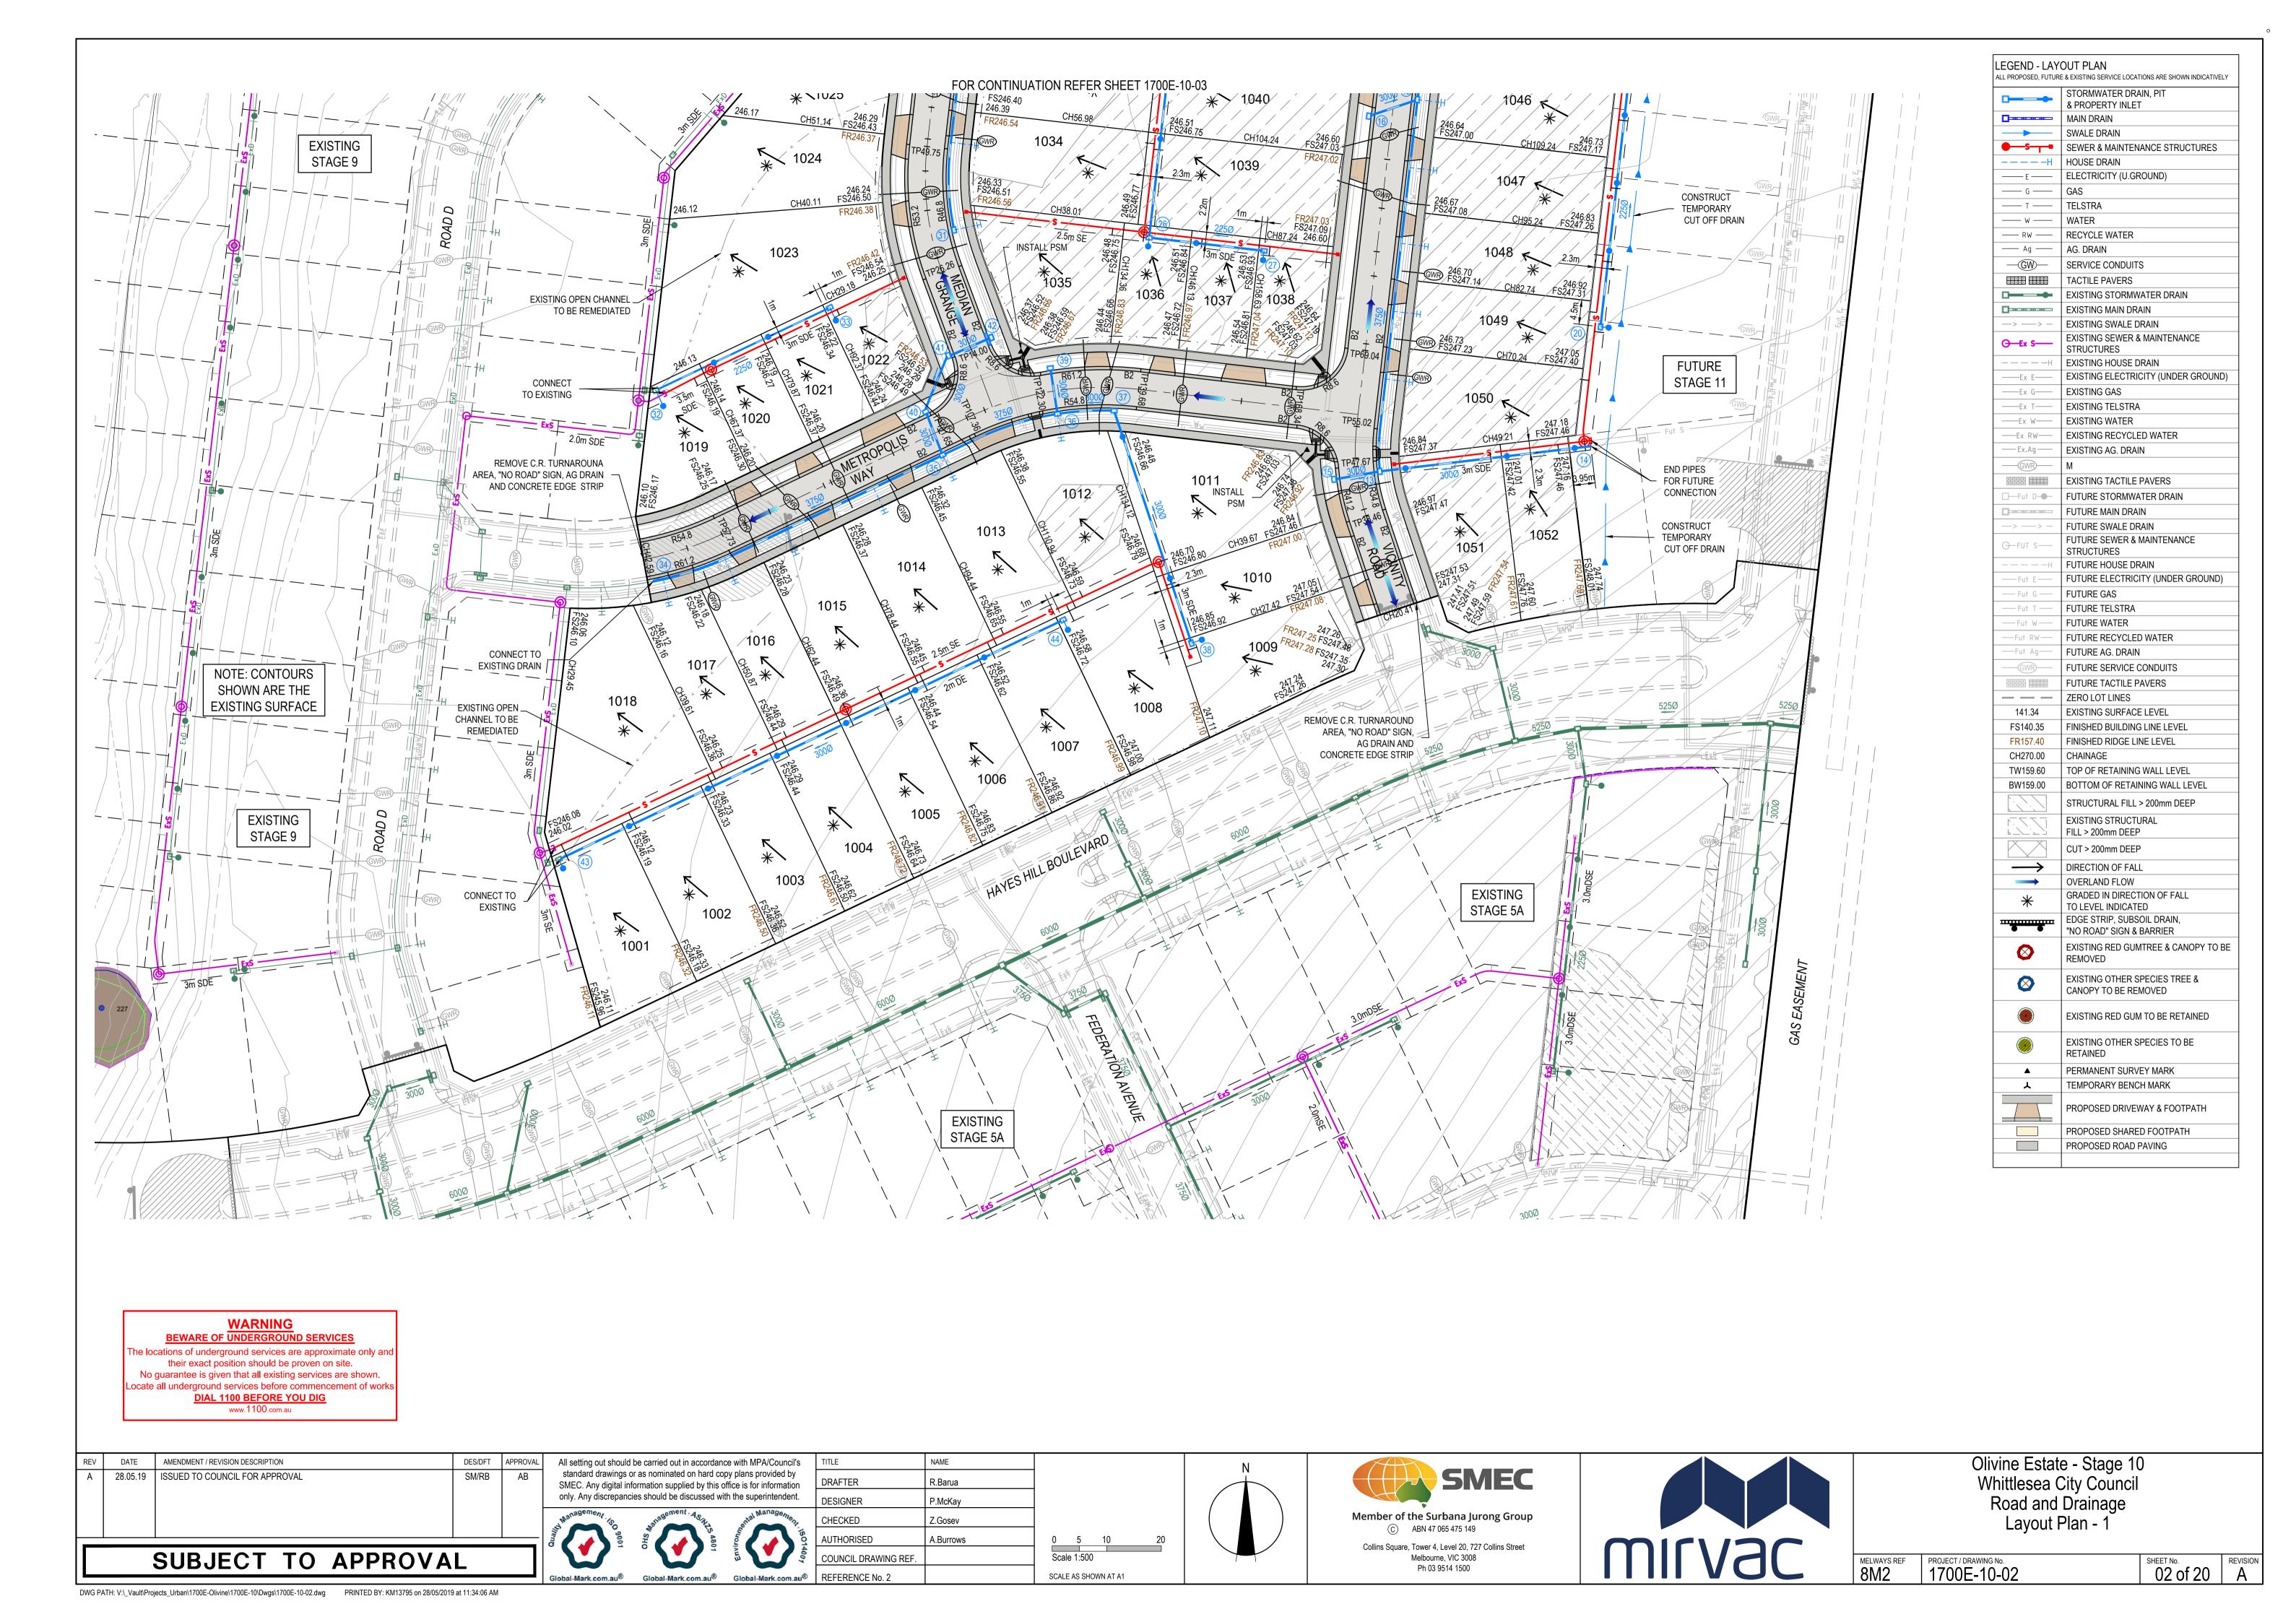








Olivine Estate - Stage 10 Whittlesea City Council Road and Drainage Cover Plan

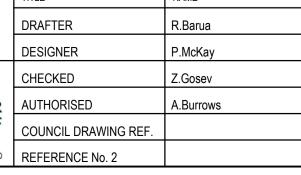
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VICINITY ROAD LONGITUDINAL SECTION

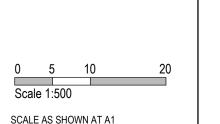

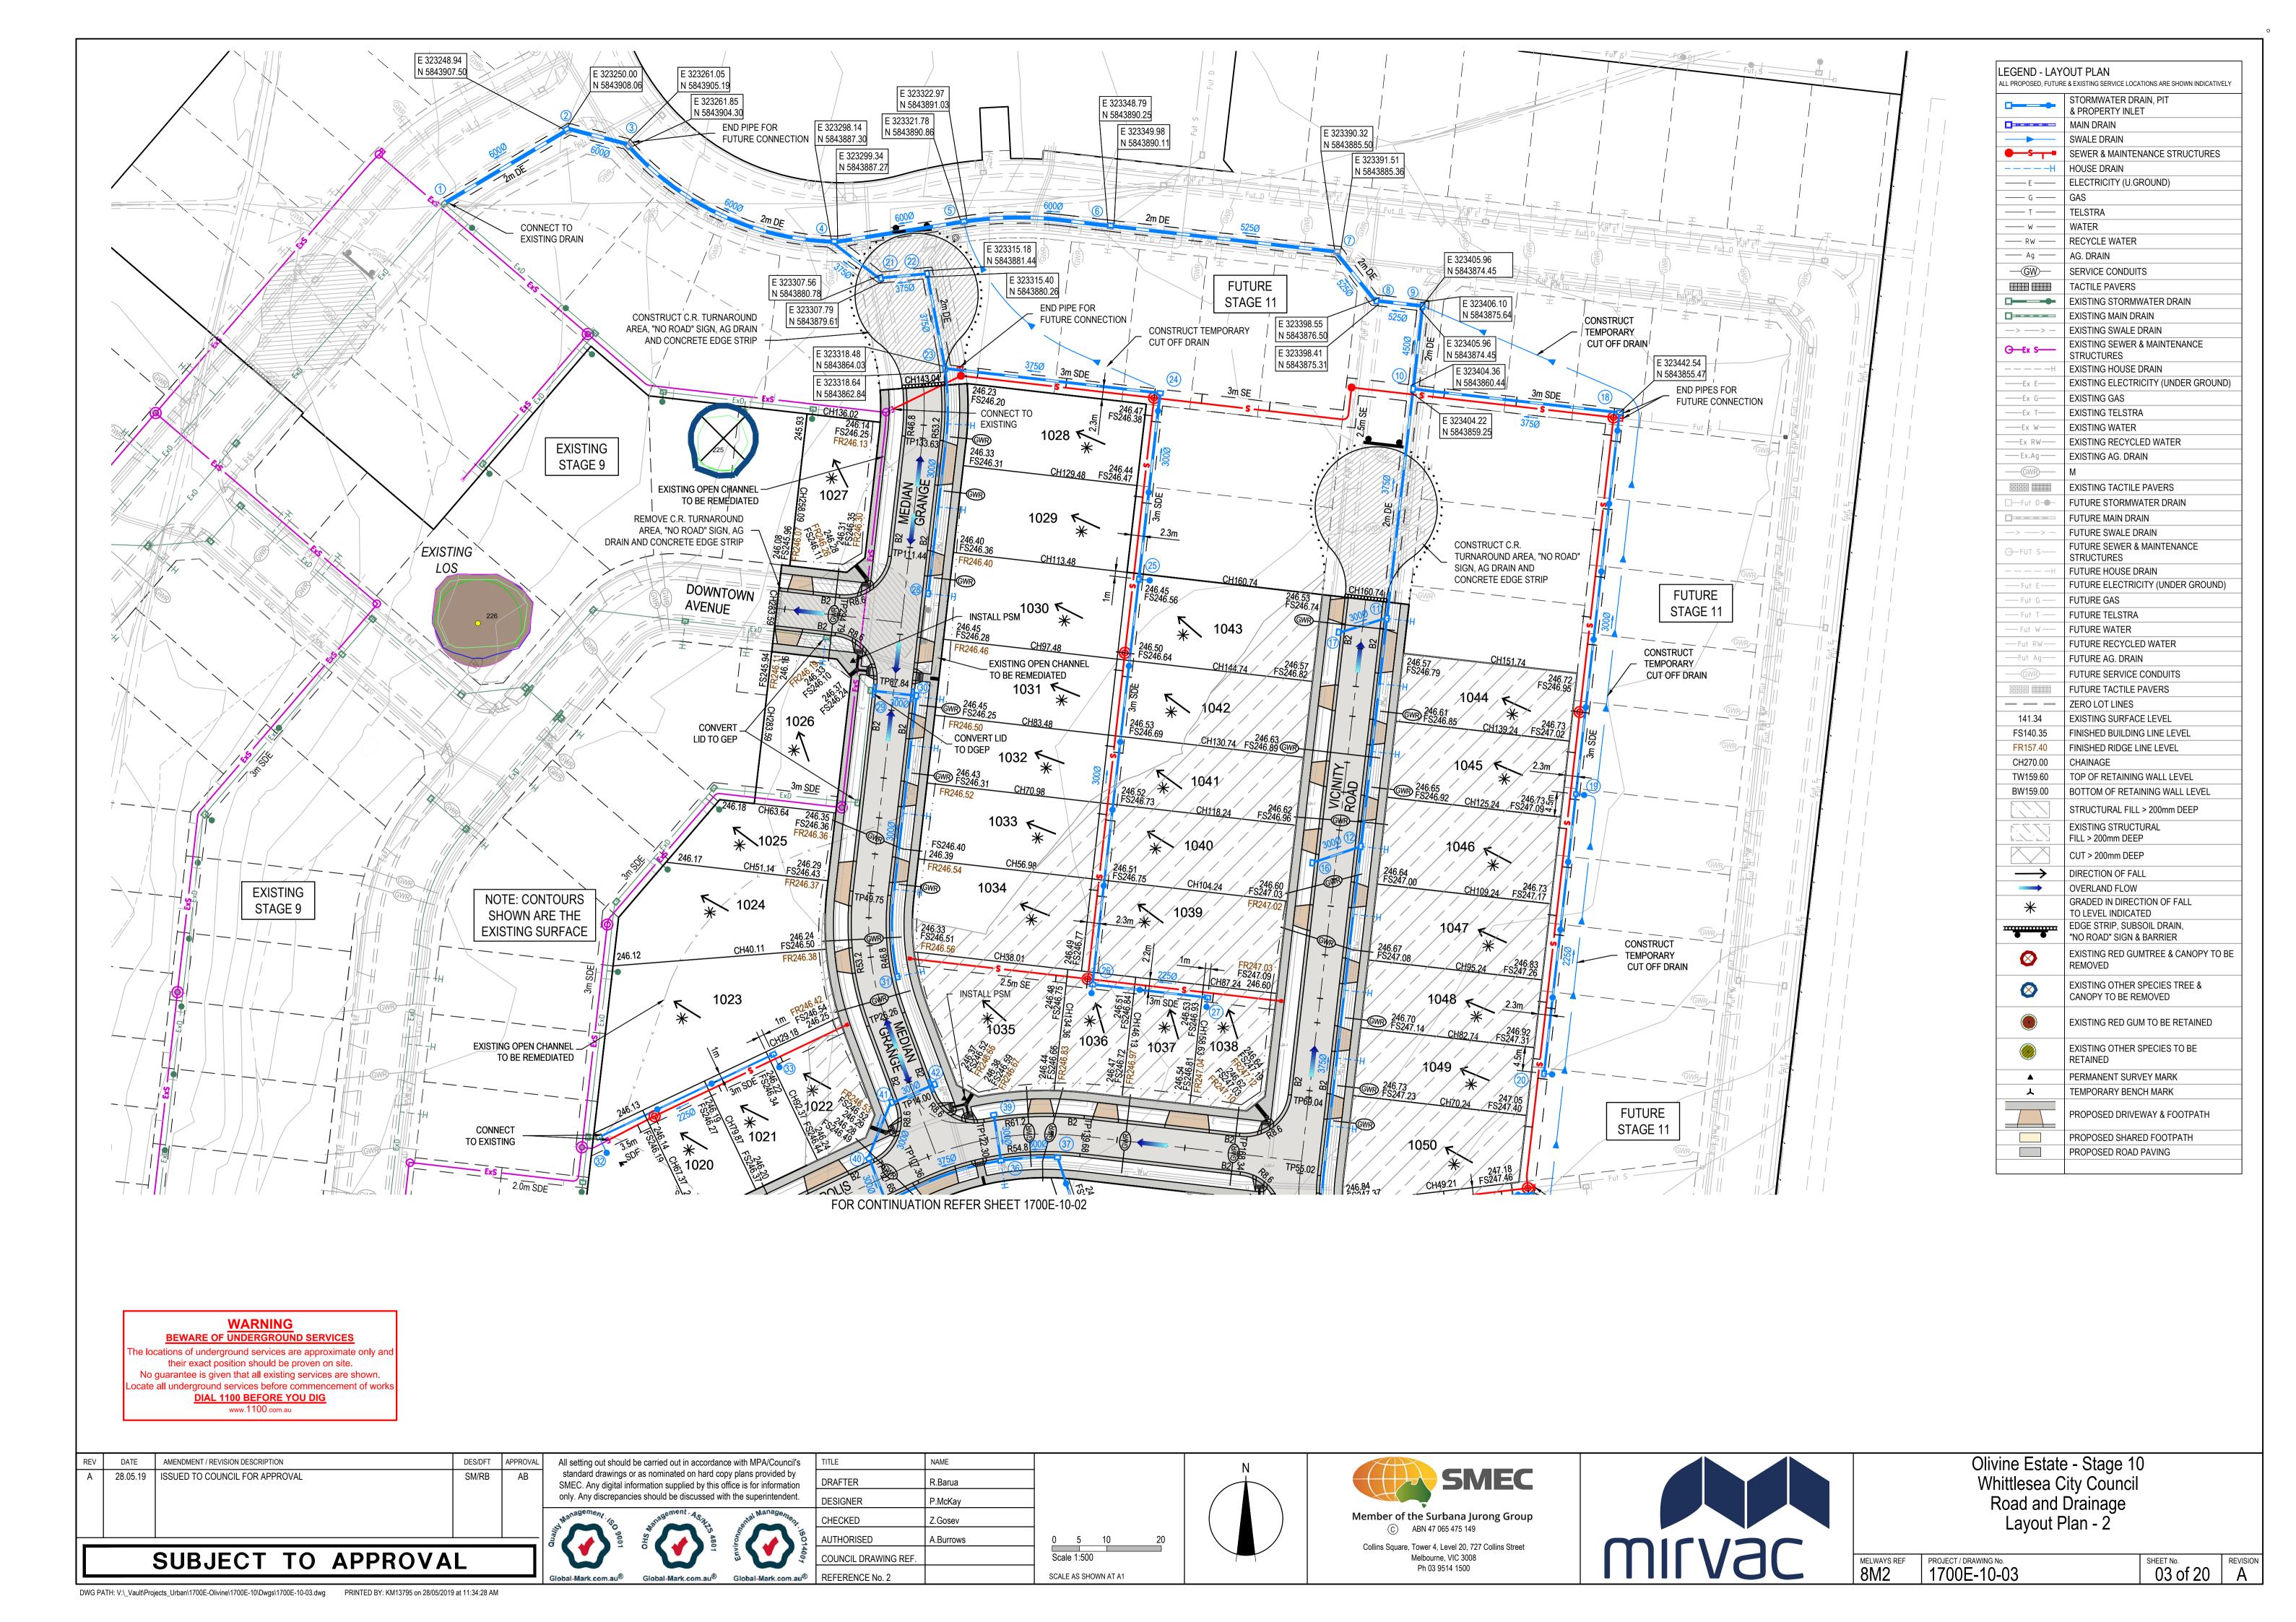METROPOLIS WAY LONGITUDINAL SECTION

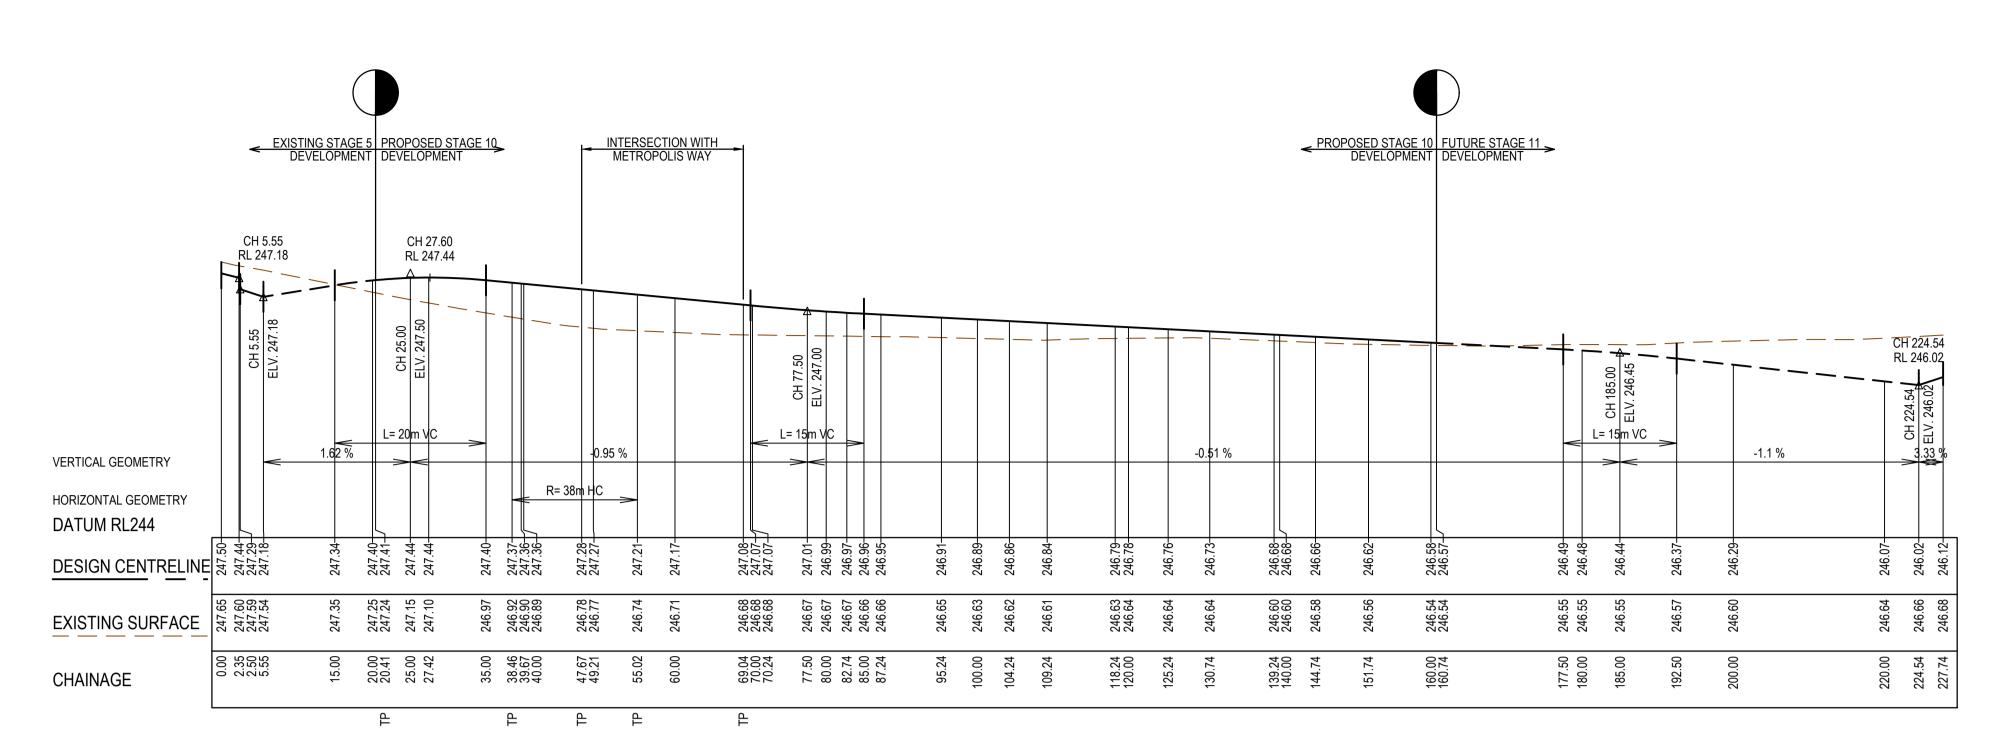
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only. Any discrepancie	es should be discussed with		DESIGNER	P.McKay
Management 100 000	SHO SHO	antal Management	CHECKED	Z.Gosev
Quality 1006	S 480	Management 50	AUTHORISED	A.Burrows
		1400 ₇	COUNCIL DRAWING REF.	
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Scale H1:500, V1:50 SCALE AS SHOWN AT A1




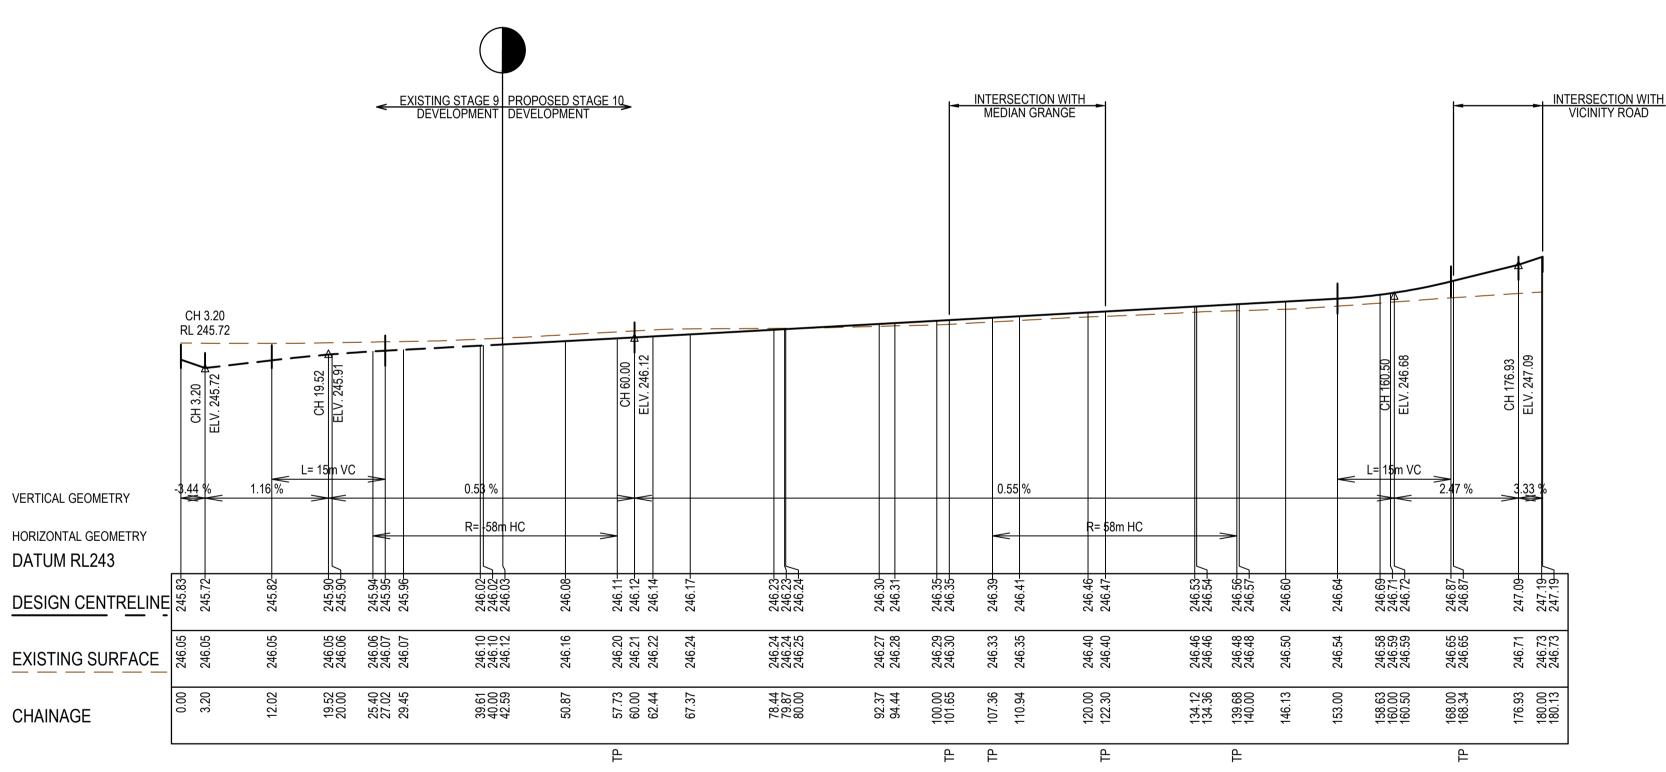

Olivine Estate - Stage 10 Whittlesea City Council Road and Drainage Longitudinal Sections - 1

PROJECT / DRAWING No. 1700E-10-04 MELWAYS REF 8M2

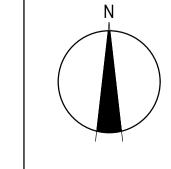SHEET No. REVISION A

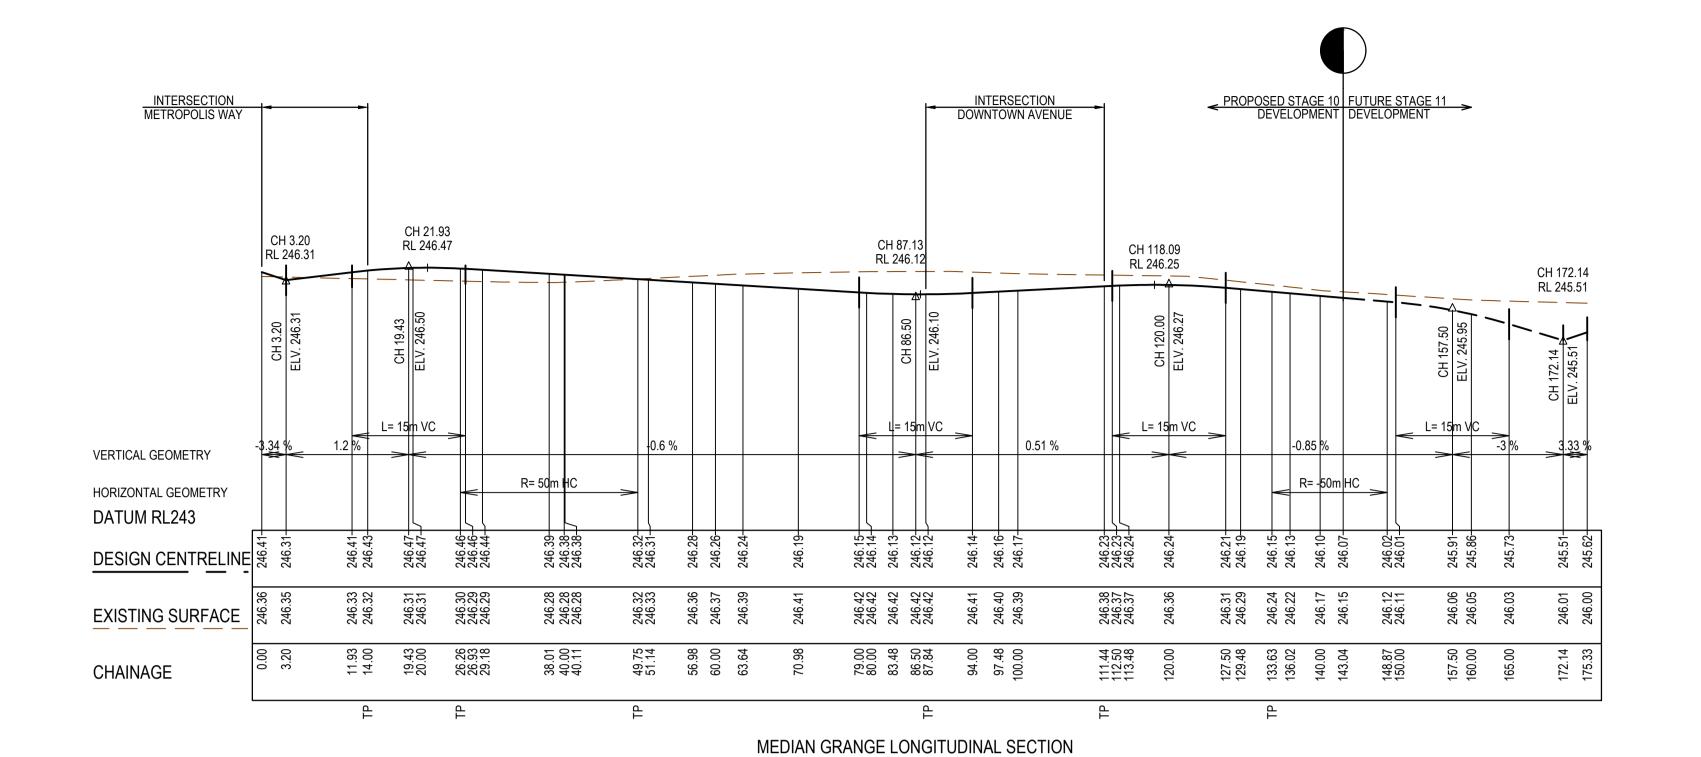


EXISTING STAGE 9 PROPOSED STAGE 10 > CH 303.39 ELV. 246.06 CH 232.06 RL 245.24 = CH 213.0 M ELV. 245. 동 글 L= 15m VC -0.55 % -0.5 % 1.23 % VERTICAL GEOMETRY R= 38m HC R= 16m HC HORIZONTAL GEOMETRY DATUM RL243 245.77-245.82-245.84-245.37-245.37-EXISTING SURFACE 8. 8.8. 8.8. 246.00 246.08 246.11 246.30 246.35 246.37 246.40 245.83 245.83 245.82 245.82 180.00 182.61 182.82 280.00 283.59 285.09 294.79 300.00 303.39 306.59 CHAINAGE


DOWNTOWN AVENUE LONGITUDINAL SECTION




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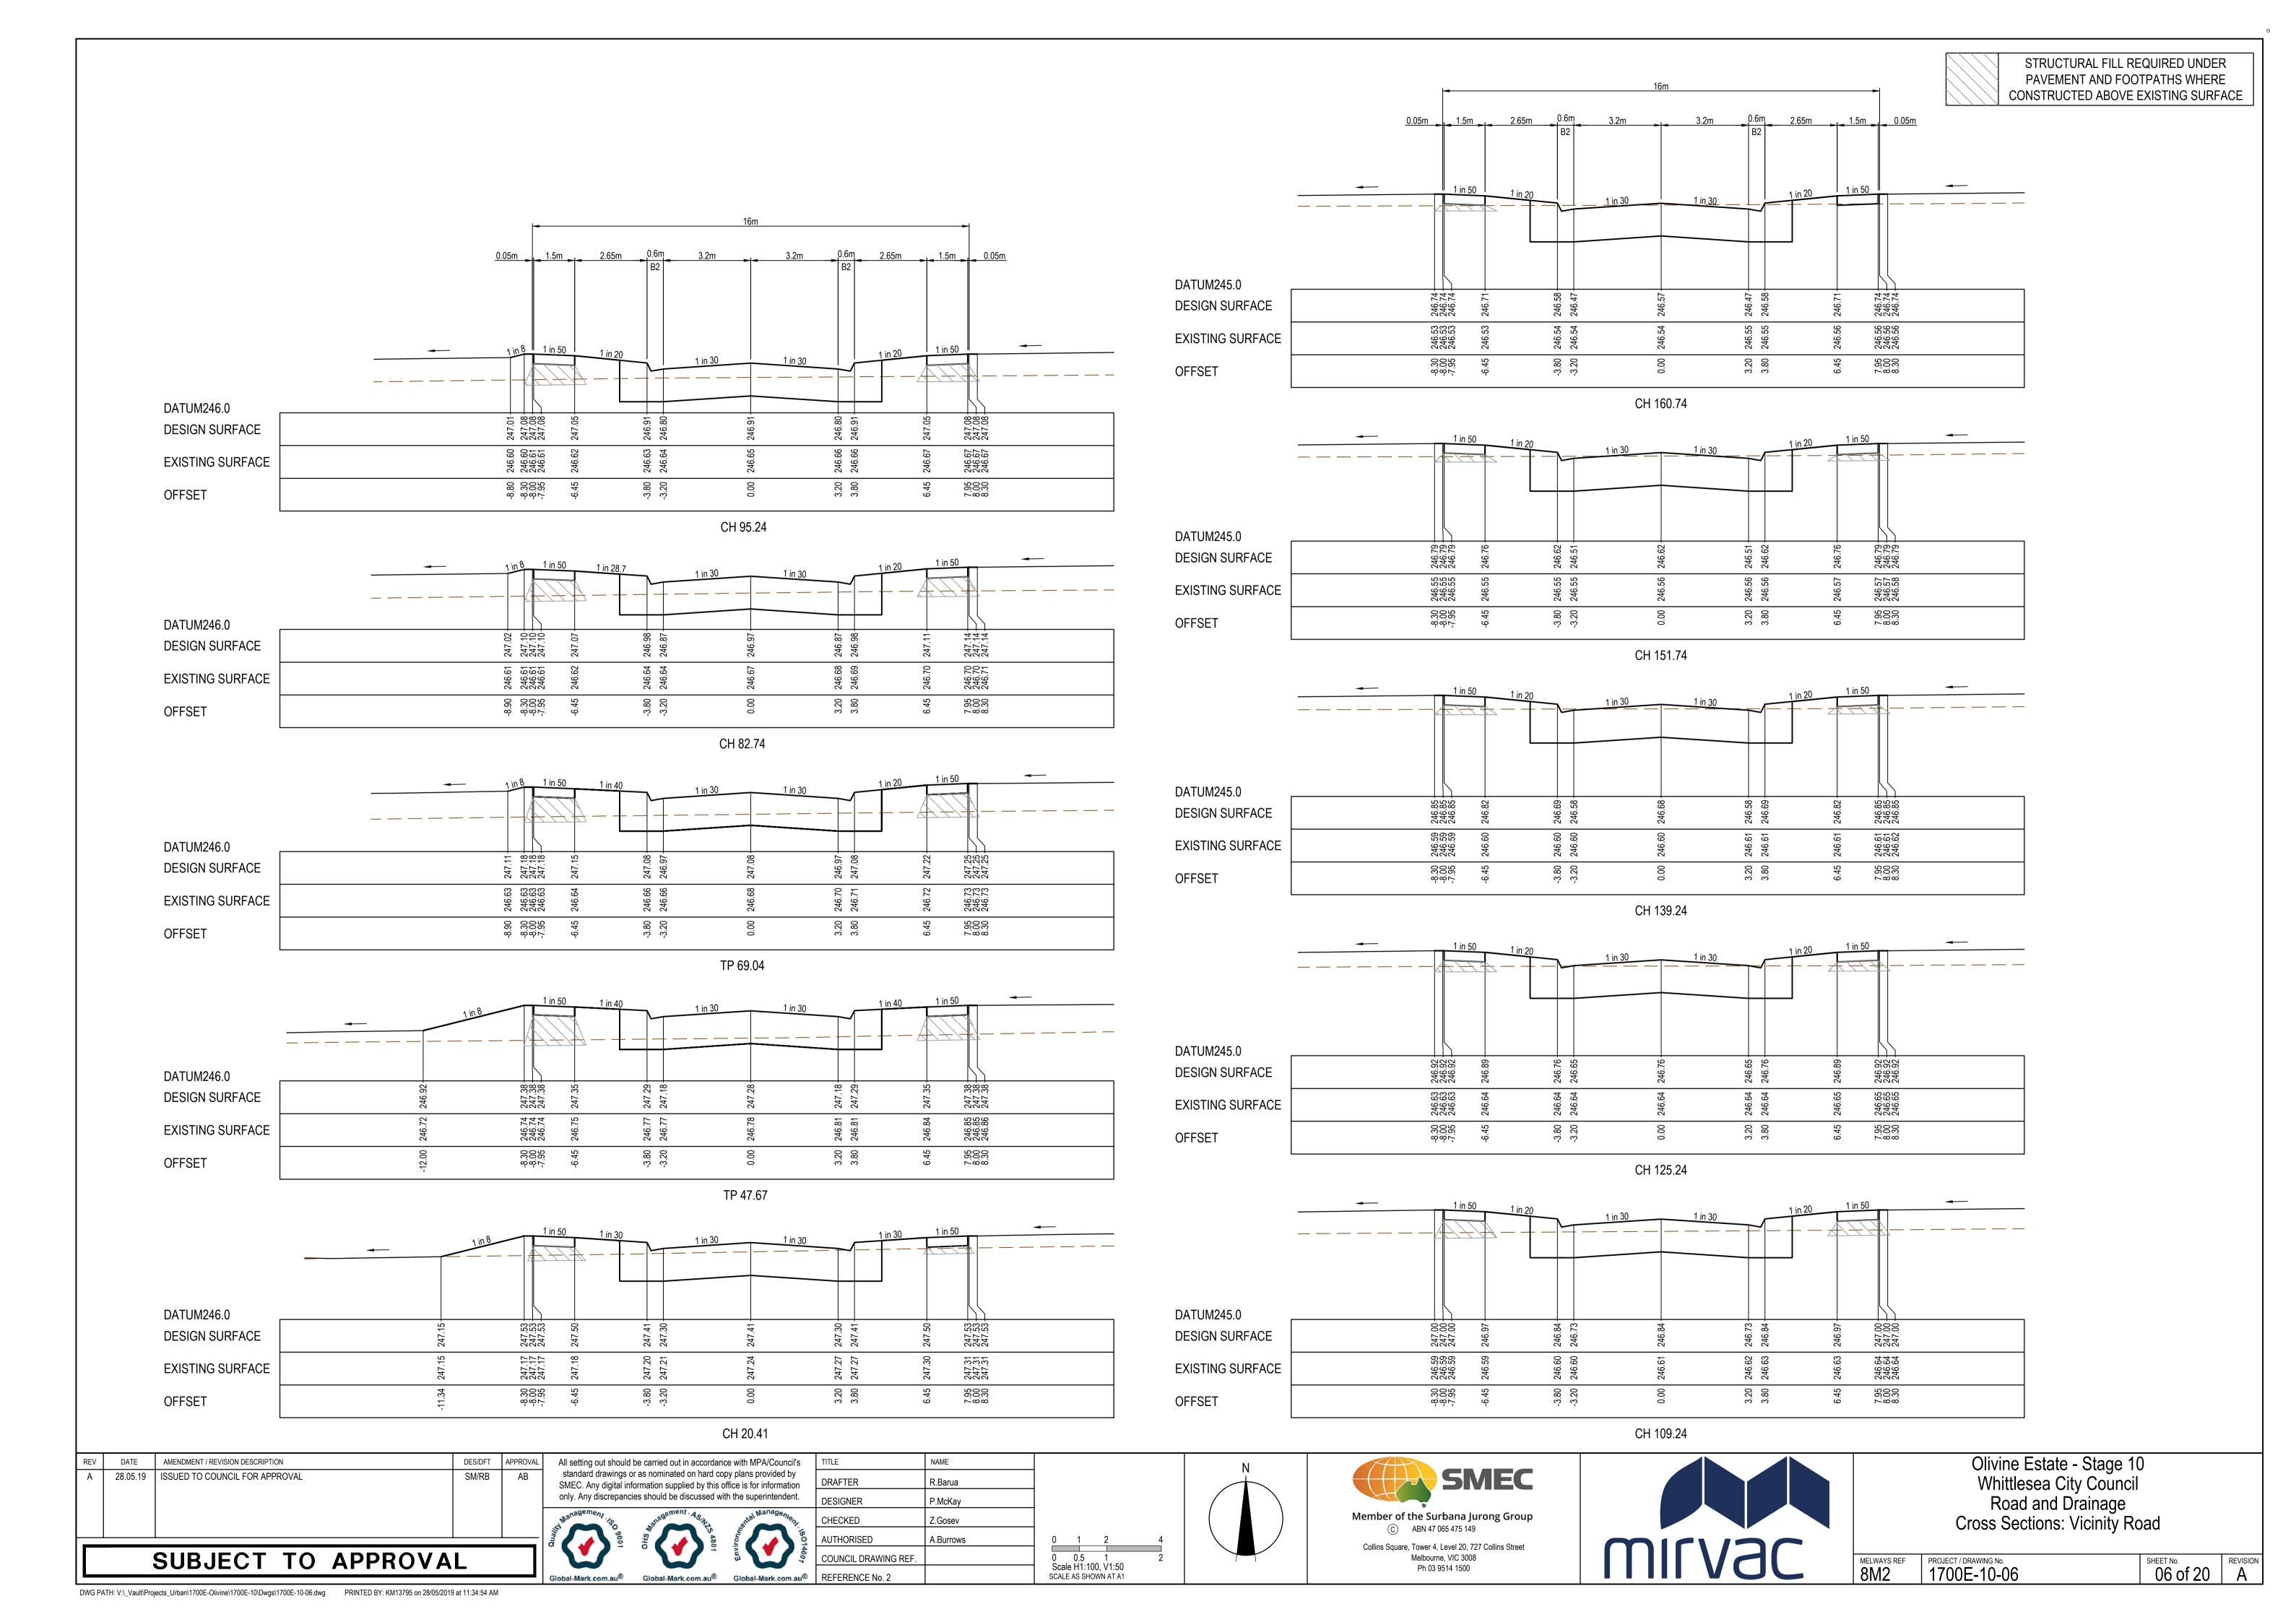


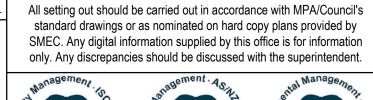



Olivine Estate - Stage 10 Whittlesea City Council Road and Drainage Longitudinal Sections - 2

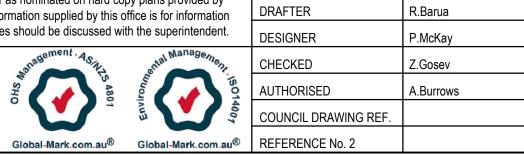
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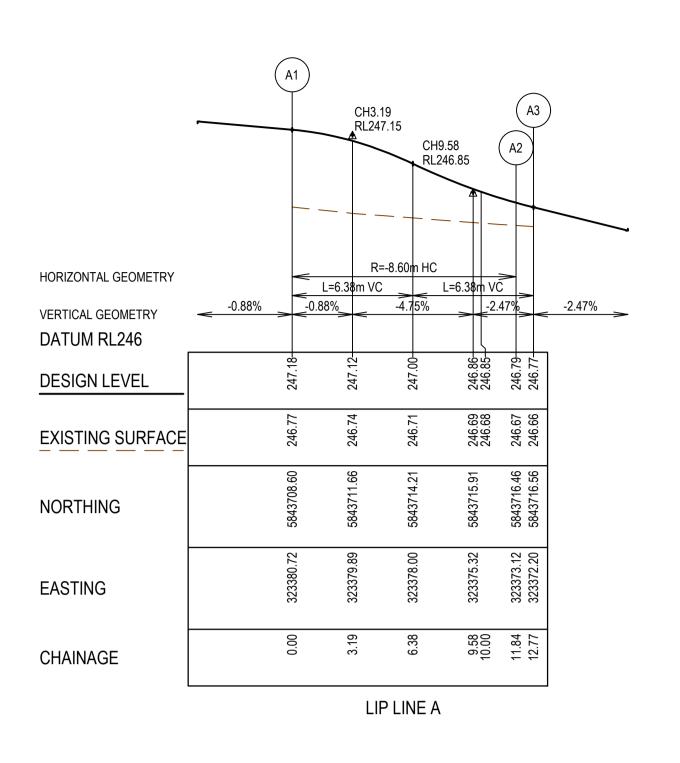
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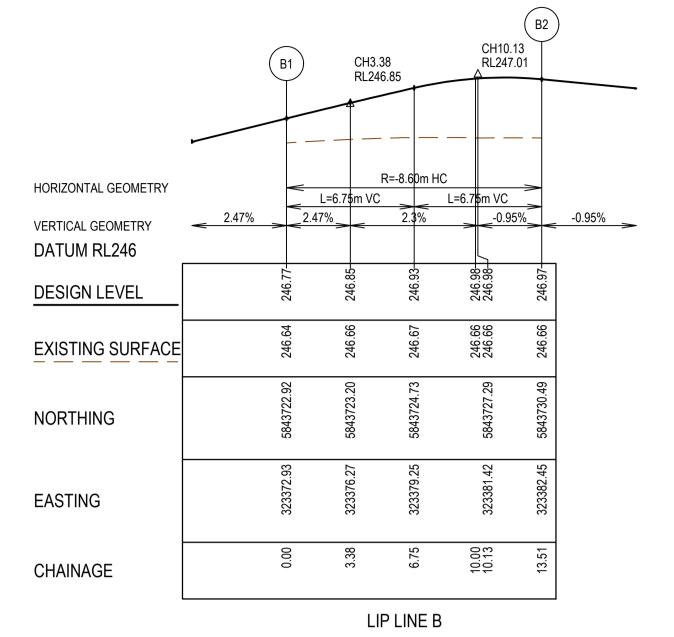


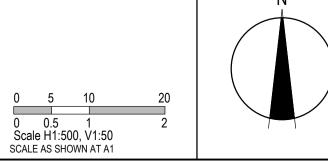




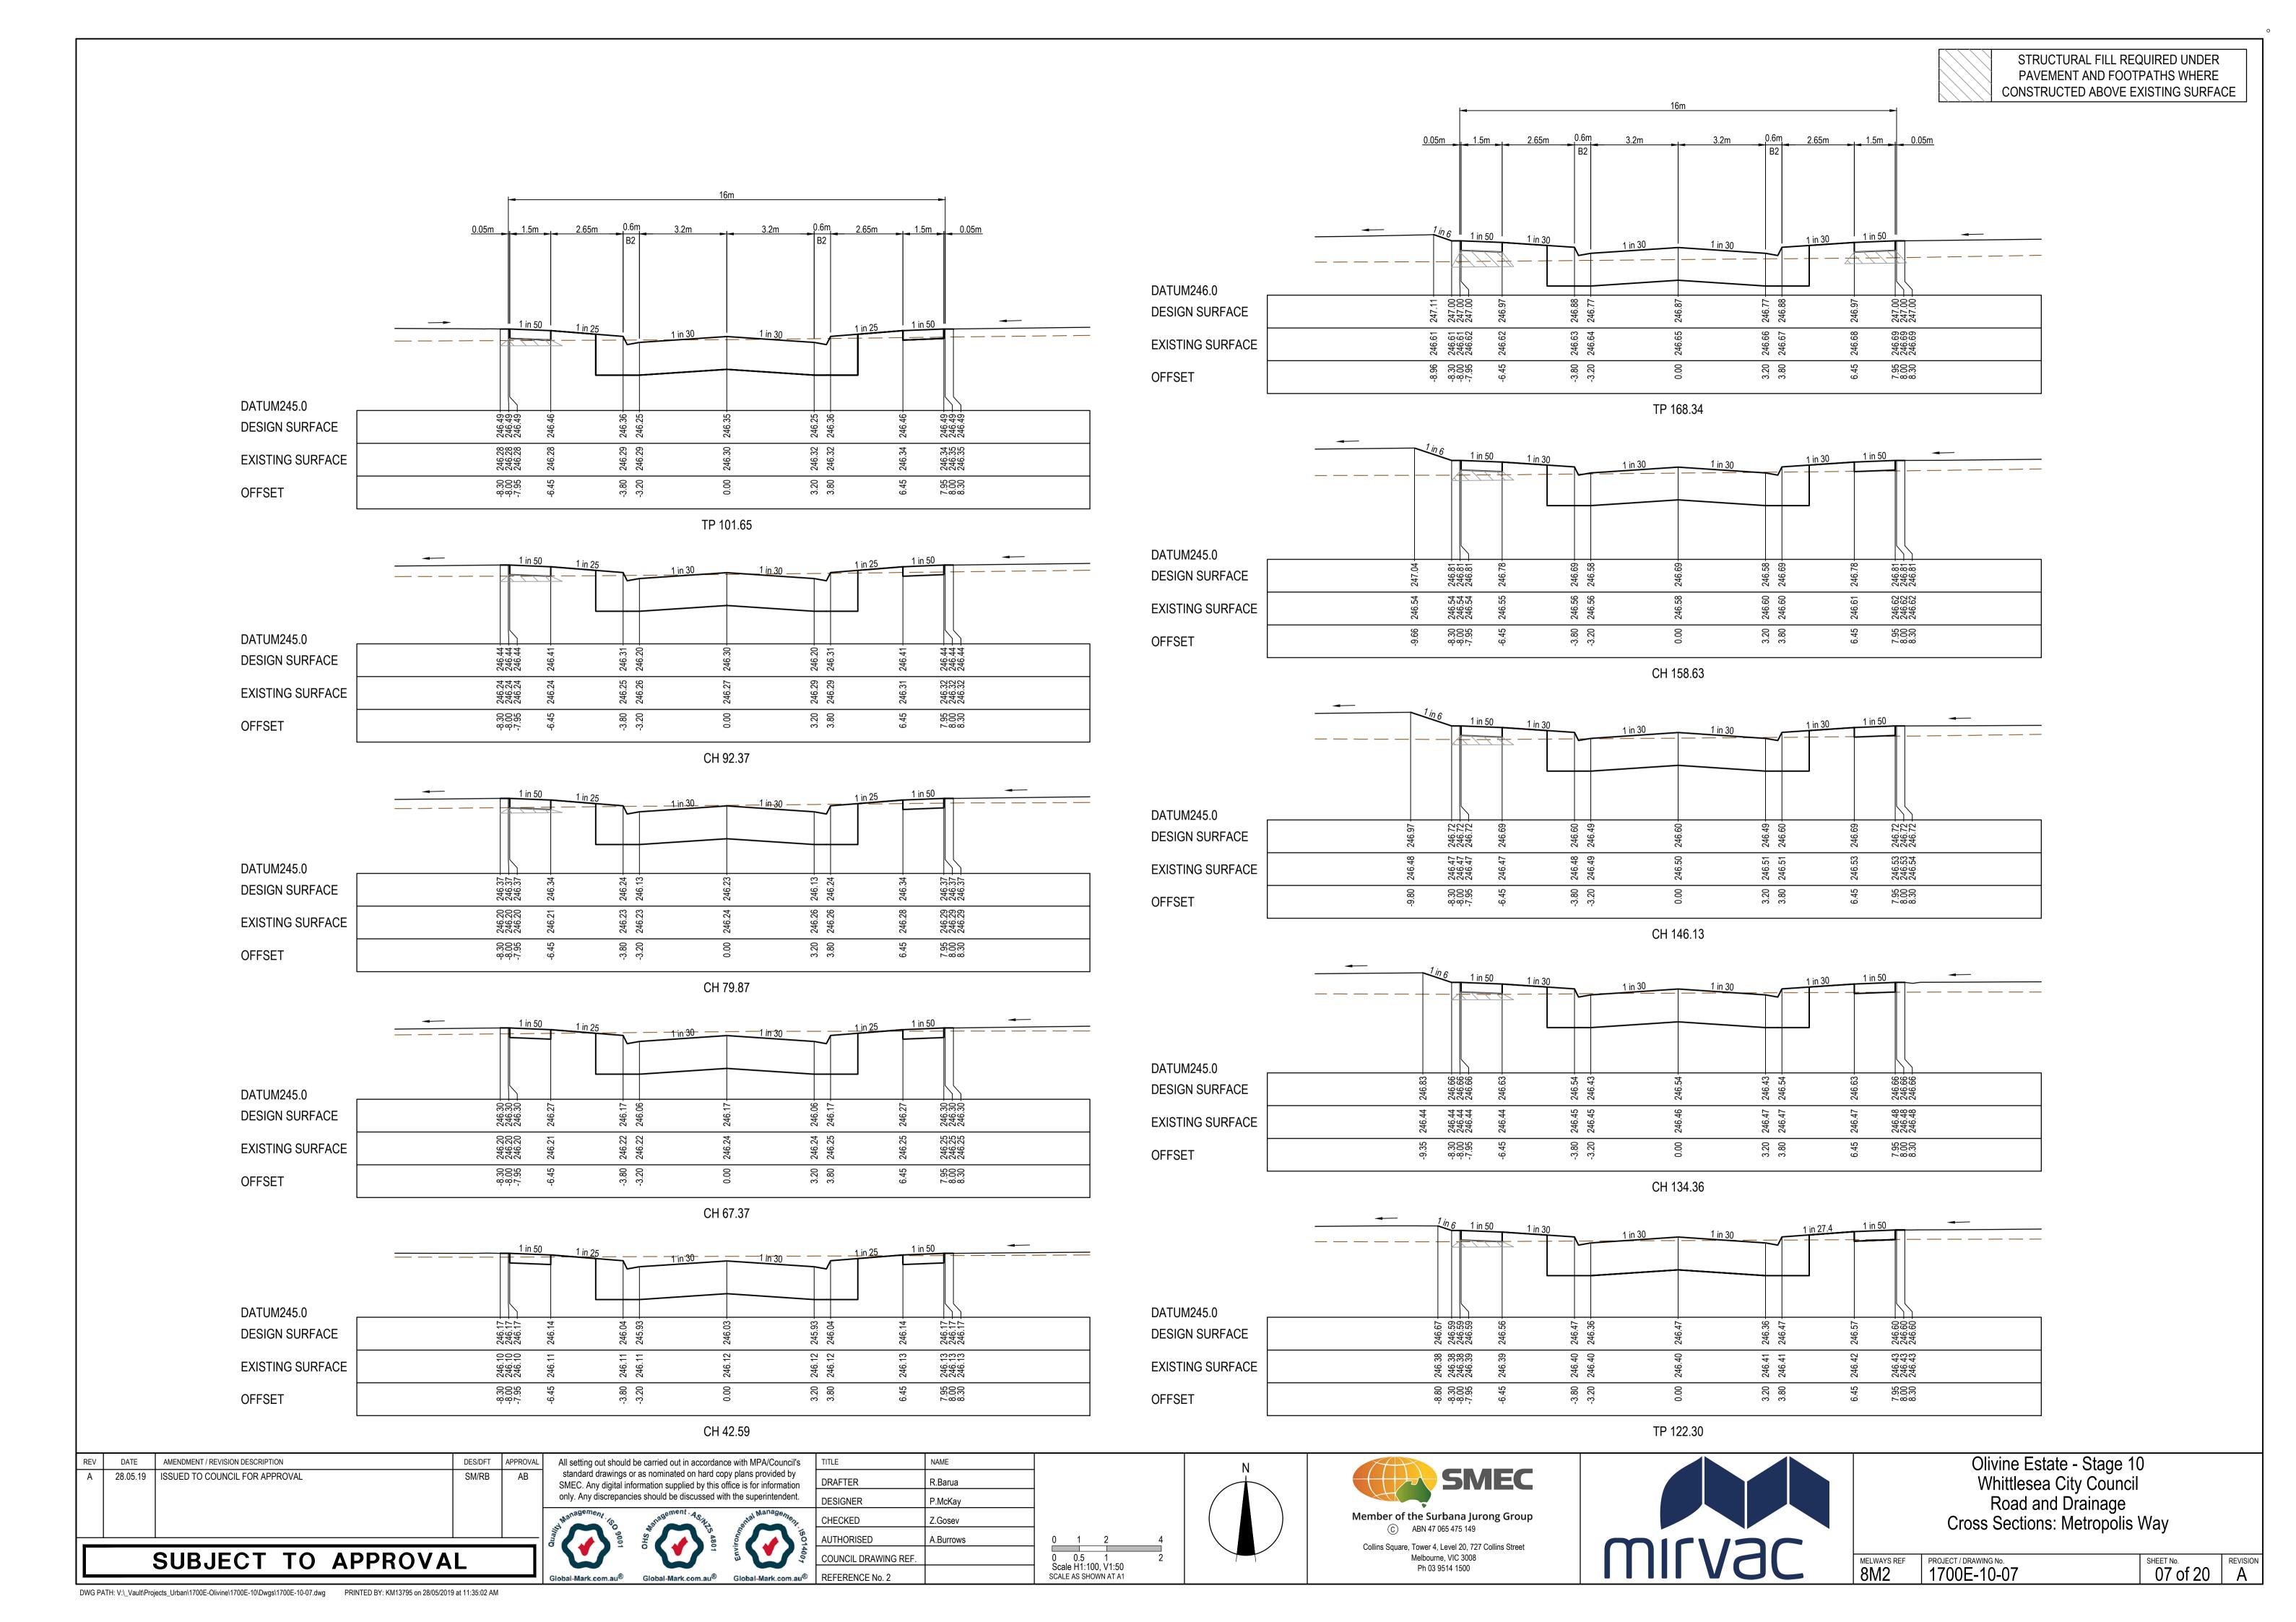

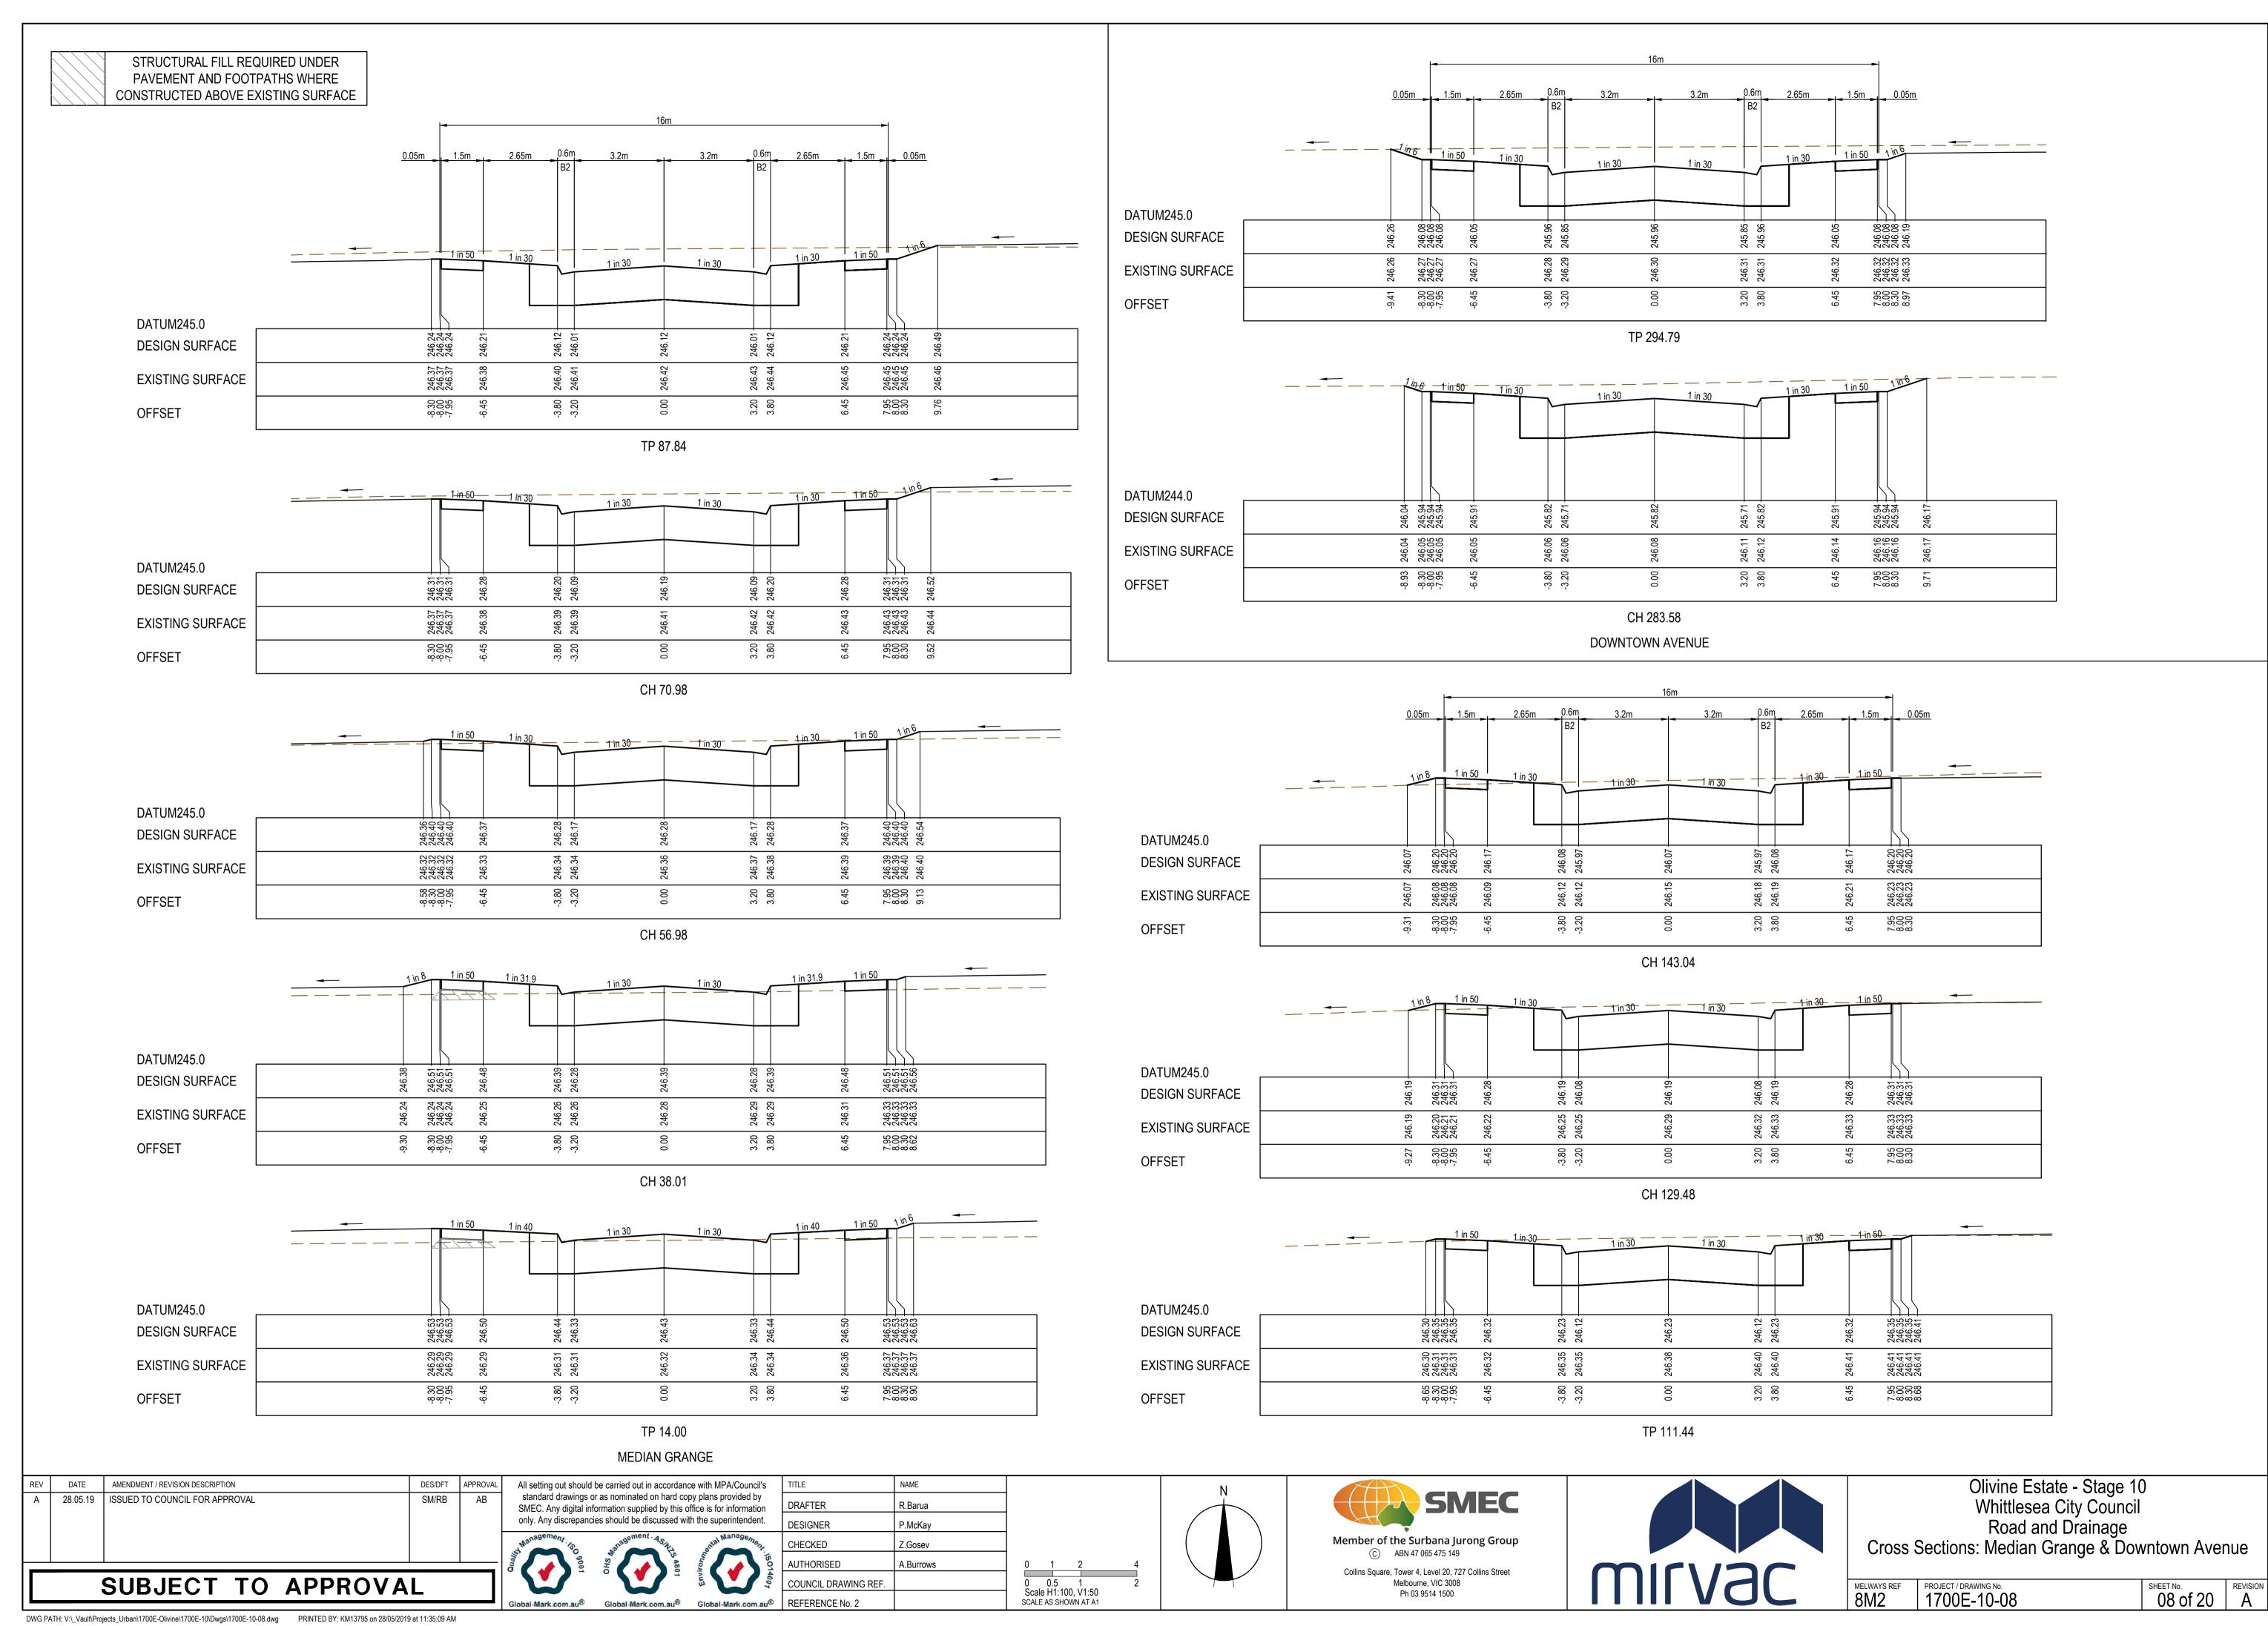


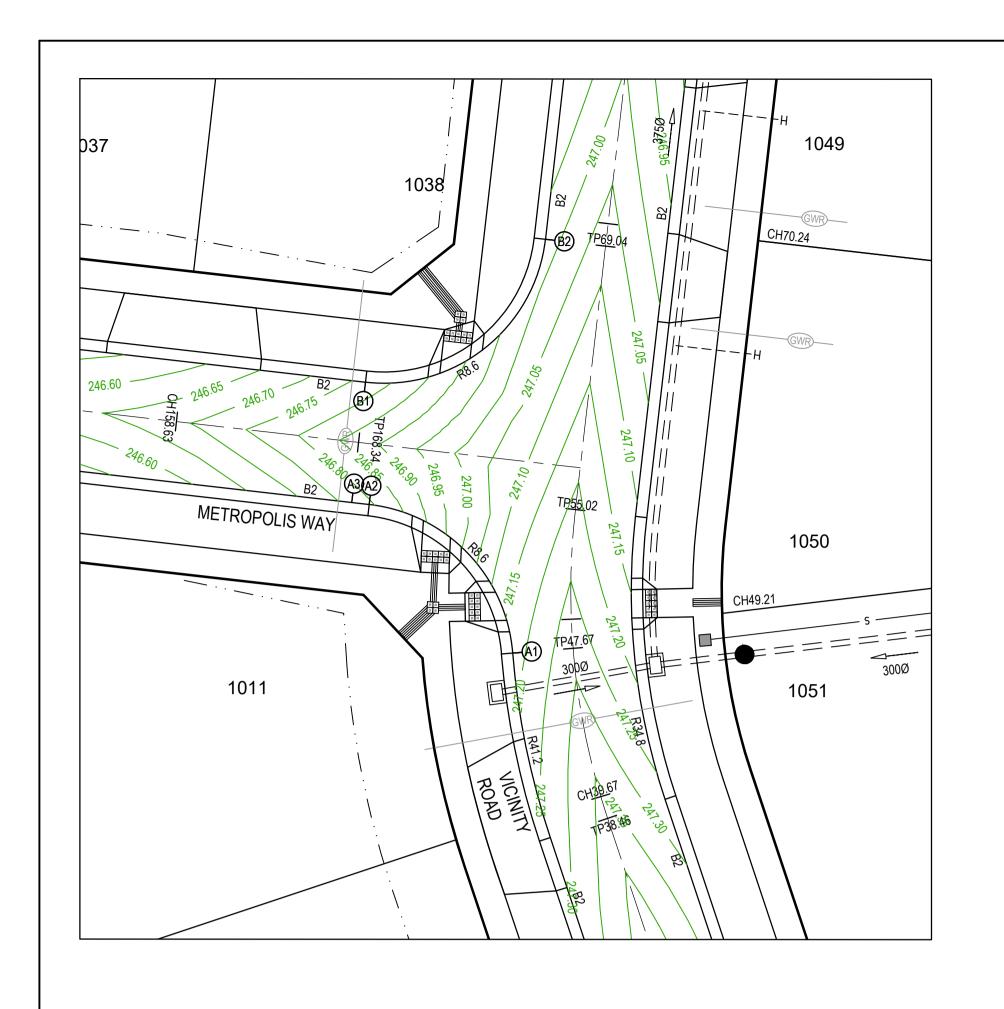


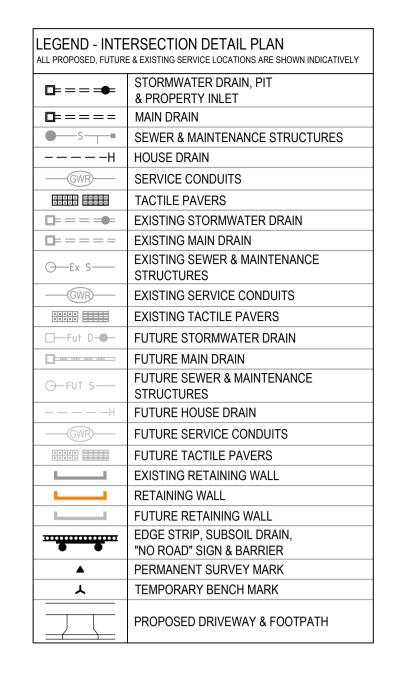


NOT

- 1. ALL VEHICLE CROSSINGS AND PRAM CROSSINGS TO BE MINIMUM OF 0.75m FROM PITS.
 2. ALL PRAM CROSSINGS TO BE MINIMUM OF 2.0m FROM VEHICLE CROSSINGS.
- VEHICLE EXCLUSION MEASURES BETWEEN ROAD RESERVE AND RESERVE TO FORM PART OF THE LANDSCAPE WORKS.
- INDUSTRIAL DRIVEWAYS TO COUNCIL RESERVES TO BE PROVIDED AS PART OF LANDSCAPE WORKS.
- 5. SHARE PATH THROUGH CREEK CORRIDOR TO FORM PART OF LANDSCAPE WORKS.

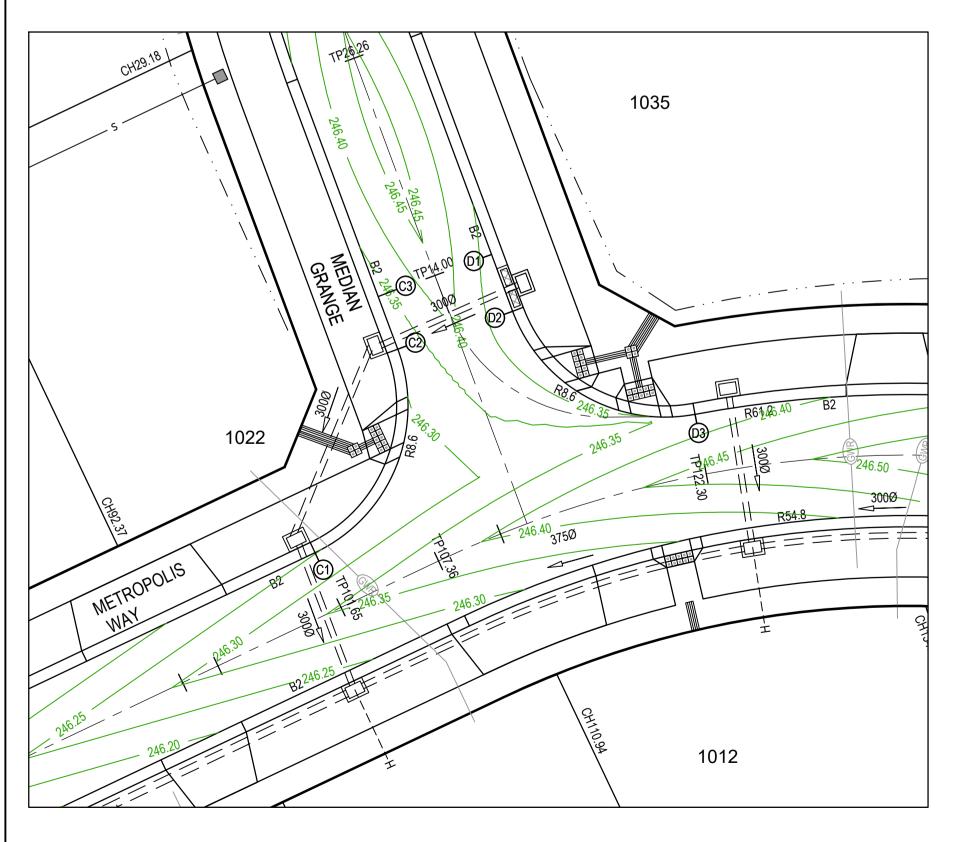

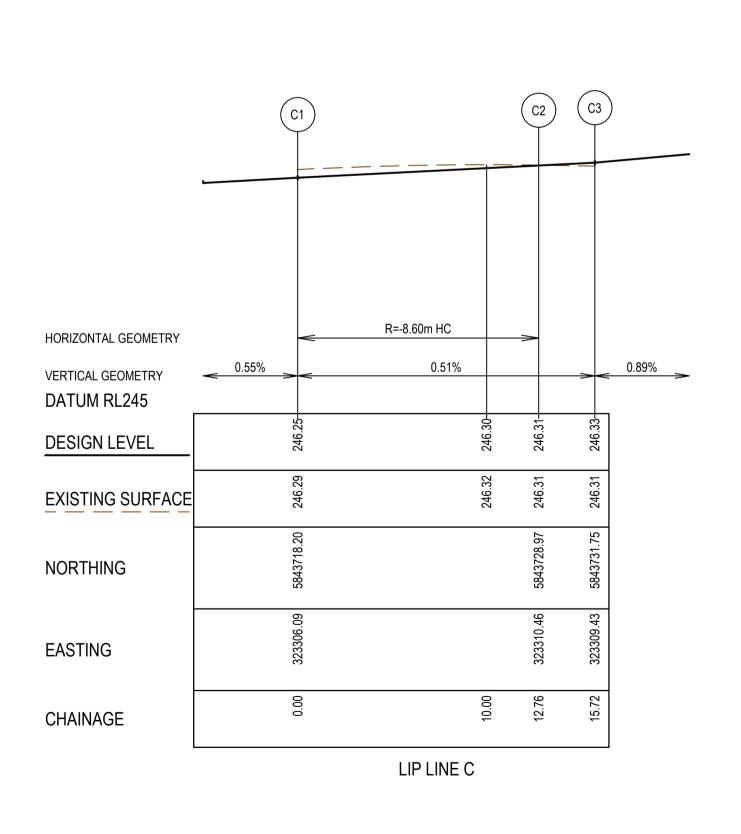

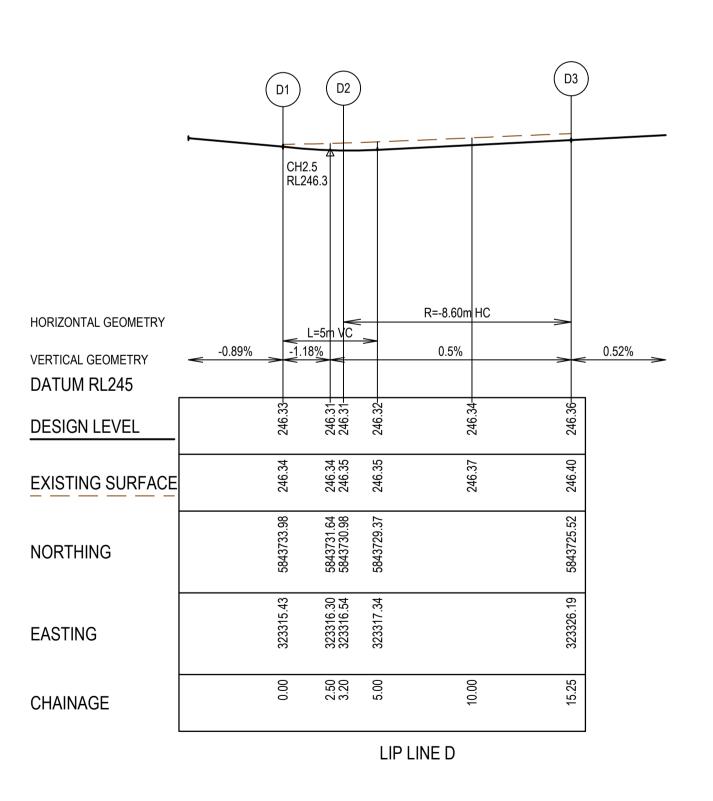

REV	DATE	AMENDMENT / REVISION DESCRIPTION	DES/DFT	APPROVAL	
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DRAFTER R.Barua


DESIGNER P.McKay


CHECKED Z.Gosev

AUTHORISED A.Burrows

COUNCIL DRAWING REF.

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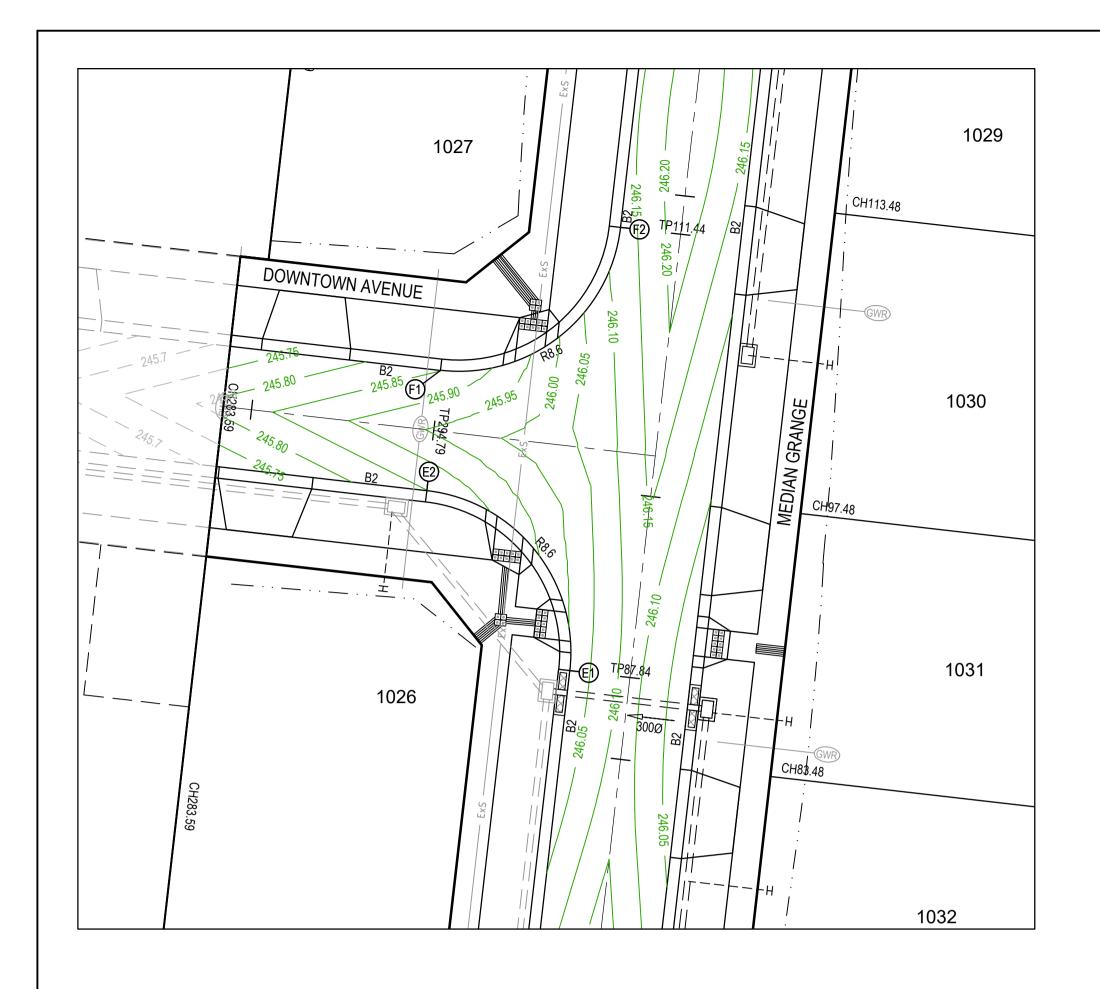


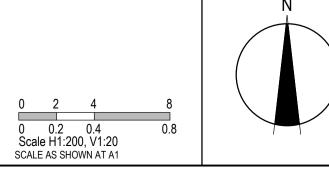


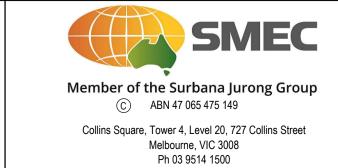
Olivine Estate - Stage 10 Whittlesea City Council Road and Drainage Intersection Detail Plan & Lip Profiles - 1


MELWAYS REF PROJECT / DRAWING No. 1700E-10-09

SHEET No. REVISION A



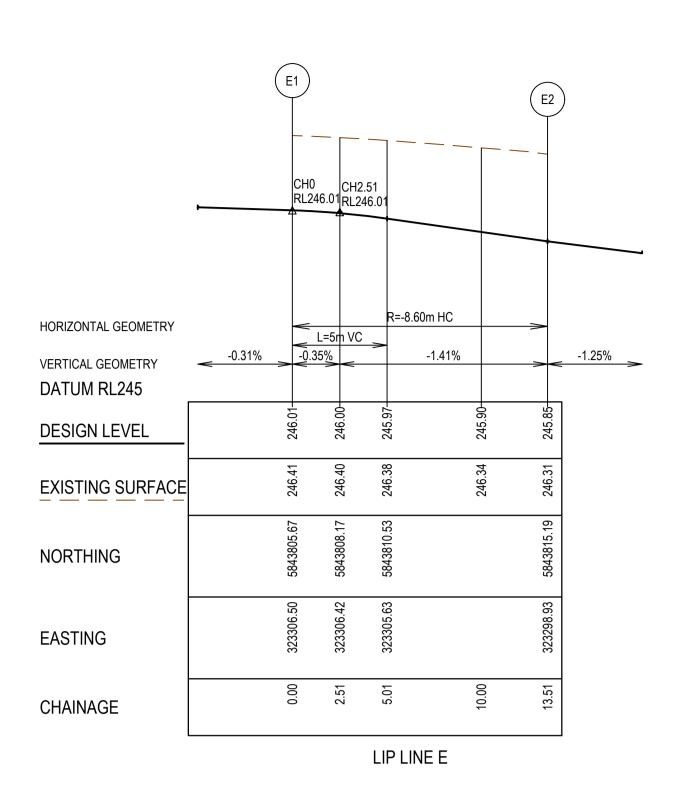

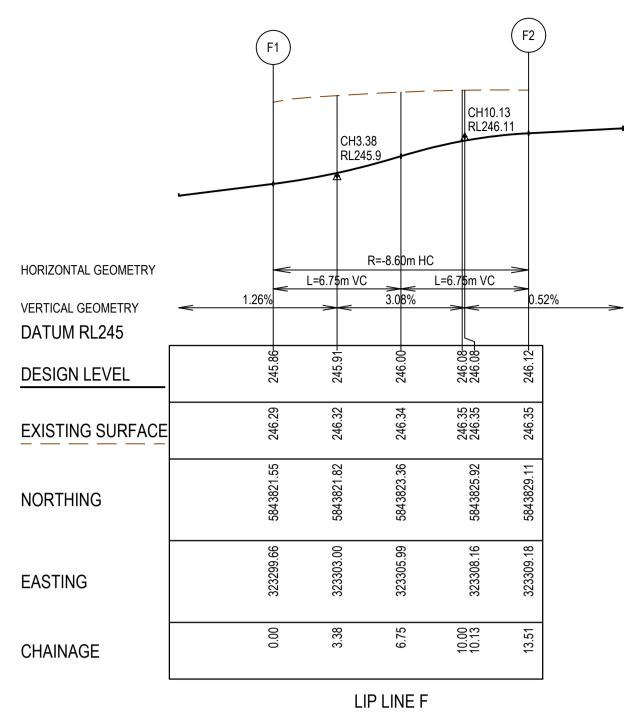

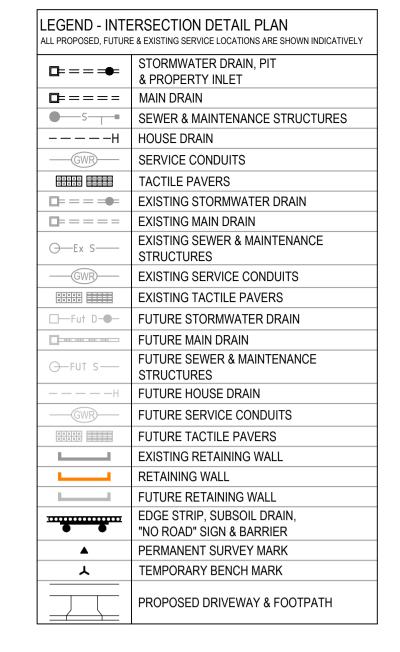

- ALL VEHICLE CROSSINGS AND PRAM CROSSINGS TO BE MINIMUM OF 0.75m FROM PITS ALL PRAM CROSSINGS TO BE MINIMUM OF 2.0m FROM VEHICLE CROSSINGS.
- VEHICLE EXCLUSION MEASURES BETWEEN ROAD RESERVE AND RESERVE TO FORM PART OF THE LANDSCAPE WORKS.
- INDUSTRIAL DRIVEWAYS TO COUNCIL RESERVES TO BE PROVIDED AS PART OF LANDSCAPE WORKS.
- SHARE PATH THROUGH CREEK CORRIDOR TO FORM PART OF LANDSCAPE WORKS.

DOWNTOWN AVENUE DESIGN LINE

IP CHAINAGE X COORD Y COORD Z COORD TYPE BEARING LENGTH RADIUS 1 283.585 323288.169 5843819.640 245.818 IP 96°31'31.28" 2 306.585 323311.020 5843817.026 246.168 IP 96°31'31.28"

MEDIAN GRANGE DESIGN LINE

IP CHAINAGE X COORD Y COORD Z COORD TYPE BEARING LENGTH RADIUS 323317.304 5843719.741 246.415 IP 339°36'59.72" 323308.157 5843744.360 246.461 TC 339°36'59.72" 323303.991 5843755.573 246.391 IP 23.482 50.000 2 38.005 323305.350 5843767.457 246.321 CT 6°31'31.48" 323314.882 5843850.793 246.154 TC 6°31'31.48" 3 138.331 323315.419 5843855.482 246.114 IP 9.411 -50.000 4 143.036 323315.068 5843860.188 246.073 IP 355°44'30.47"

METROPOLIS WAY DESIGN LINE

IP CHAINAGE X COORD Y COORD Z COORD TYPE BEARING LENGTH RADIUS 1 42.585 323253.423 5843691.825 246.032 IP 79°33'12.93" 2 50.156 323260.910 5843693.206 246.072 IP 15.141 -58.000 57.726 323267.787 5843696.472 246.113 CT 64°35'49.04" 323312.625 5843717.765 246.386 TC 64°35'49.04" 3 123.523 323327.613 5843724.883 246.476 IP 32.321 58.000 139.684 323344.097 5843722.997 246.565 CT 96°31'31.48" 4 180.135 323384.286 5843718.400 247.193 IP 96°31'31.48"

VICINITY ROAD DESIGN LINE


IP CHAINAGE X COORD Y COORD Z COORD TYPE BEARING LENGTH RADIUS 1 20.410 323391.449 5843682.728 247.407 IP 341°33'27.33" 323385.739 5843699.851 247.372 TC 341°33'27.33" 2 46.740 323383.077 5843707.832 247.293 IP 16.559 38.000 55.019 323384.034 5843716.191 247.214 CT 6°31'31.49" 3 160.743 323396.048 5843821.230 246.575 IP 6°31'31.49"


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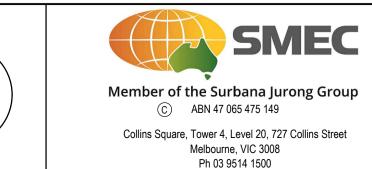
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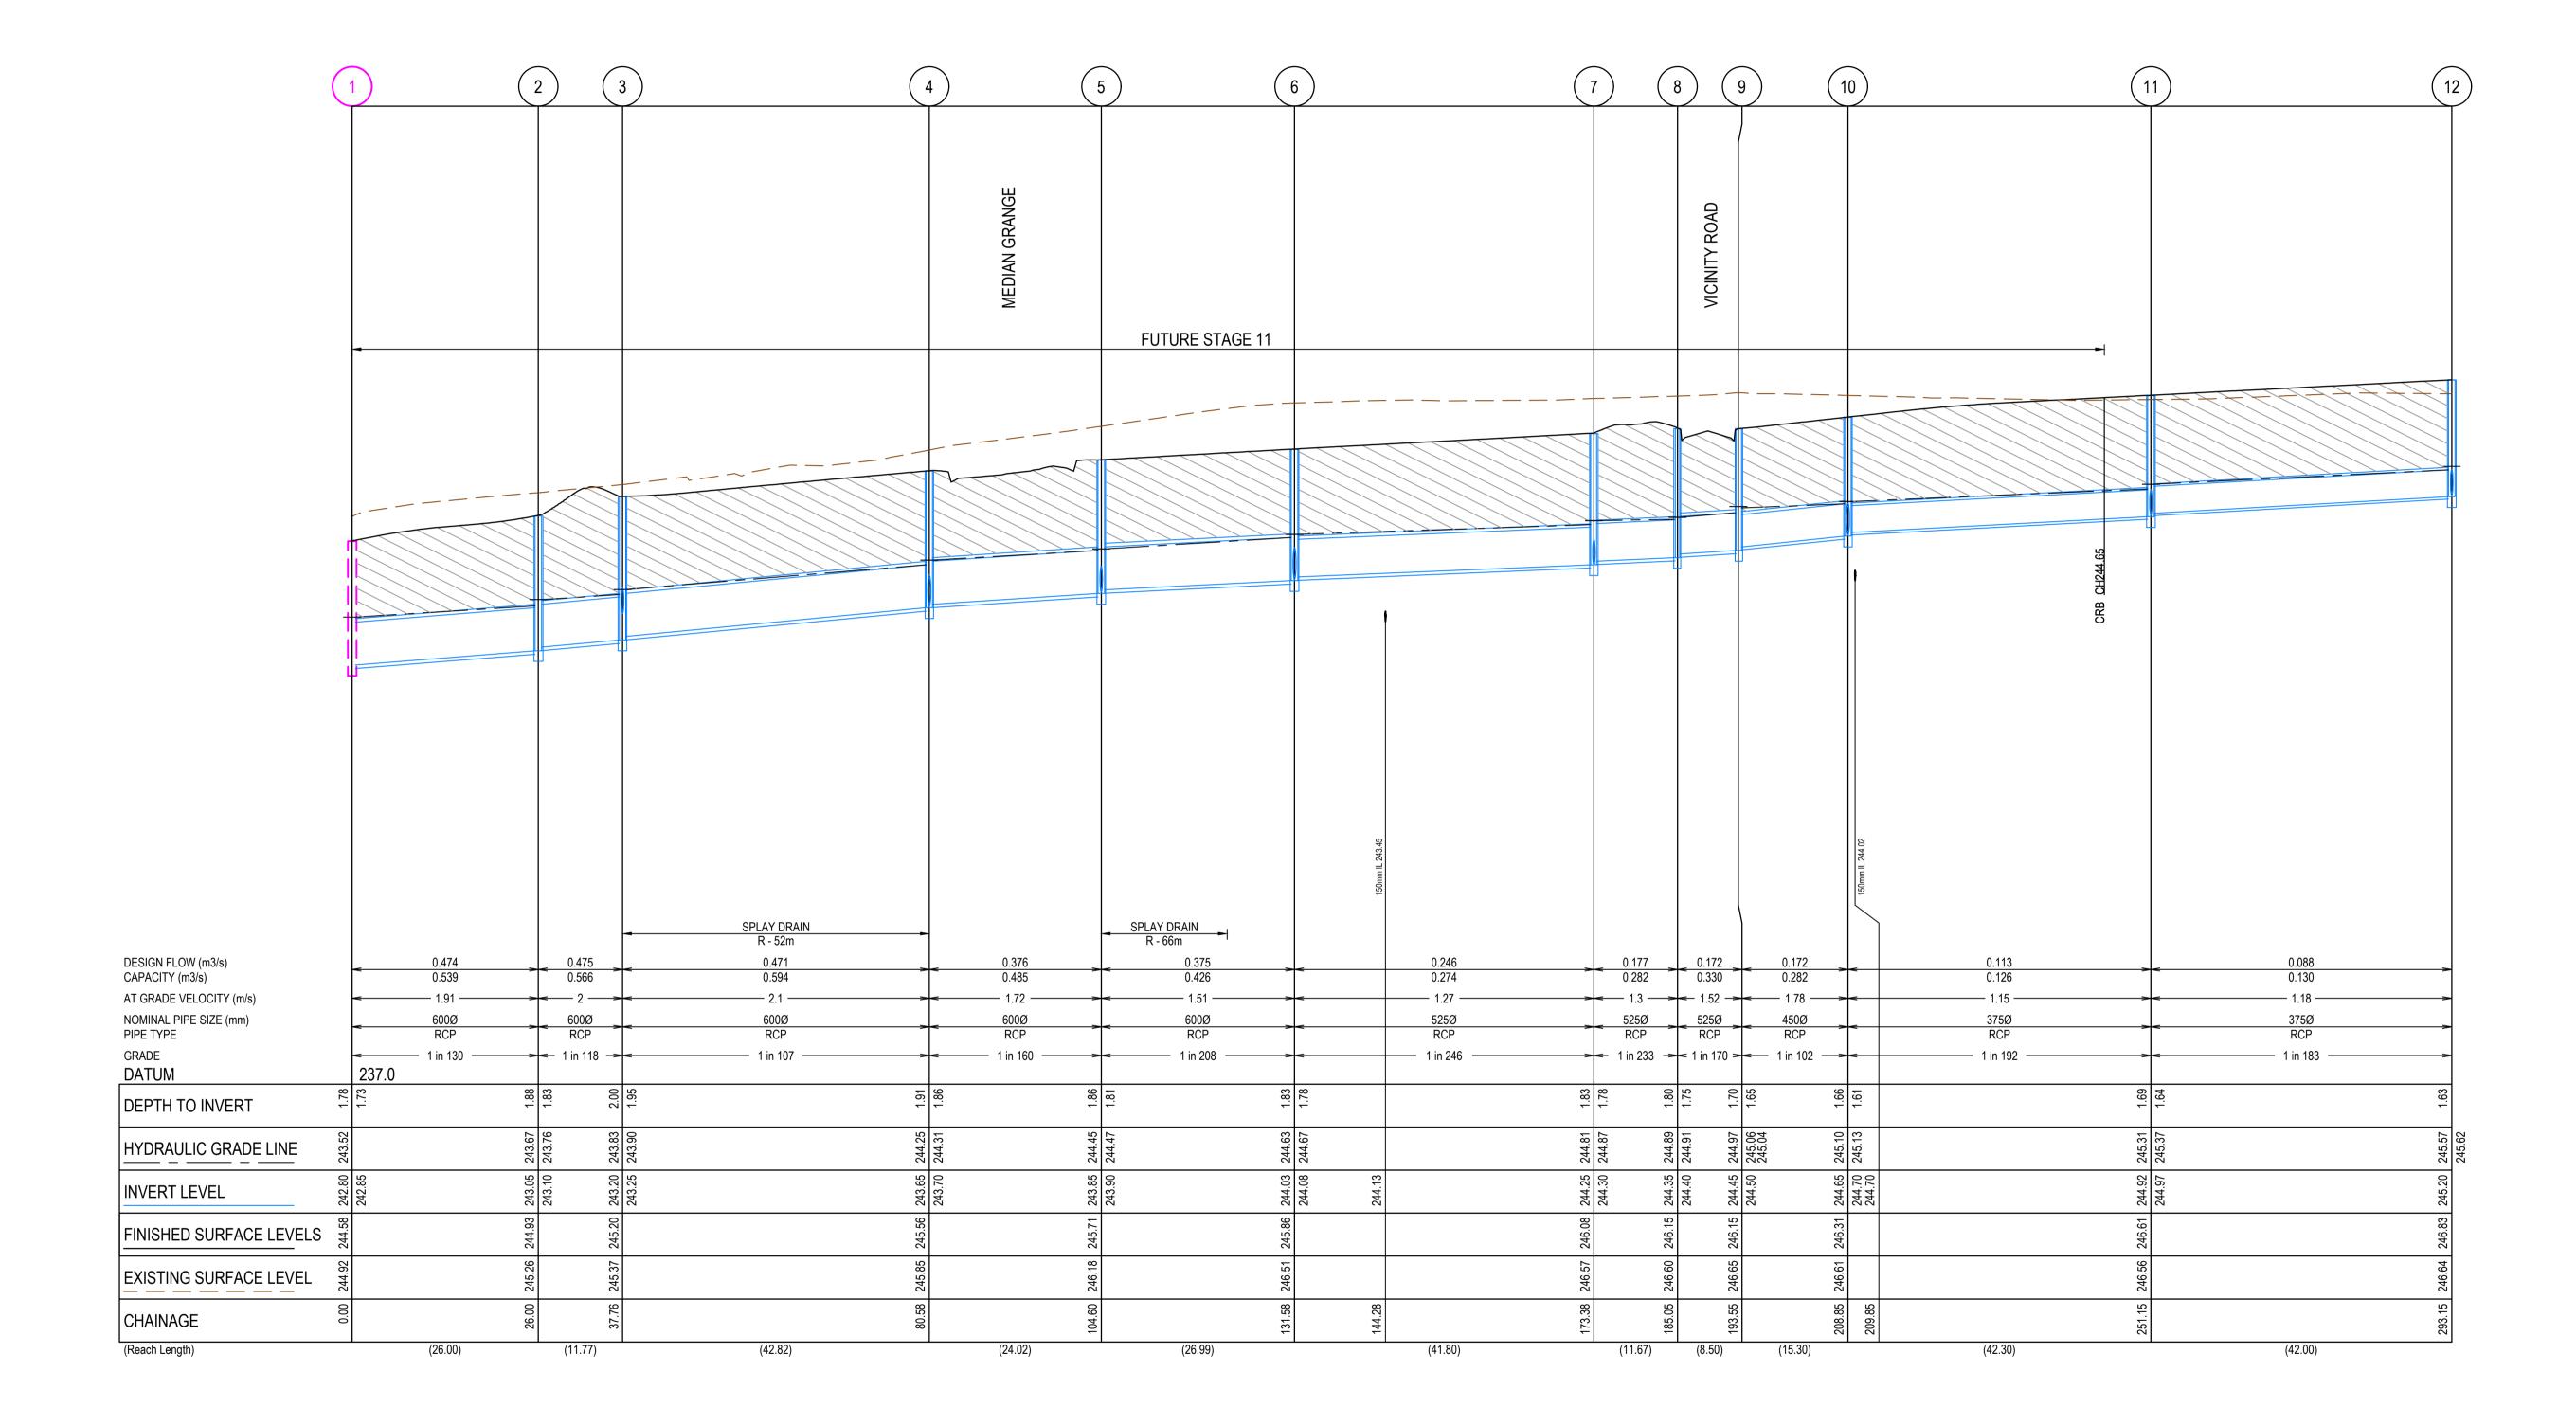
Olivine Estate - Stage 10
Whittlesea City Council
Road and Drainage
Intersection Detail Plan & Lip Profiles - 2

MELWAYS REF 8M2 PROJECT / DRAWING No. 1700E-10-10

10 of 20 A

DWG PATH: V:_Vault\Projects_Urban\1700E-Olivine\1700E-10\Dwgs\1700E-10-10.dwg PRINTED BY: KM13795 on 28/05/2019 at 11:35:36 AM

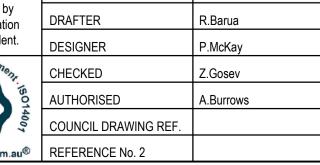CRB INDICATES CRUSHED ROCK BACKFILL COMPACTED IN ACCORDANCE SPECIFIED OTHERWISE

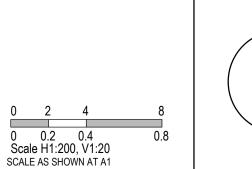

SUBJECT	TO	APPROVA	L	


AMENDMENT / REVISION DESCRIPTION

A 28.05.19 ISSUED TO COUNCIL FOR APPROVAL





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only. Any discrepanci	es should be discussed with		DESIGNER	P.McKay
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Scale H1:500, V1:50 SCALE AS SHOWN AT A1

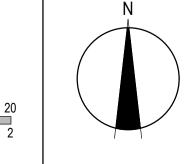




Olivine Estate - Stage 10
Whittlesea City Council
Road and Drainage
Drainage Longitudinal Sections - 1

MELWAYS REF 8M2 PROJECT / DRAWING No. 1700E-10-11

SHEET No. REVISION A

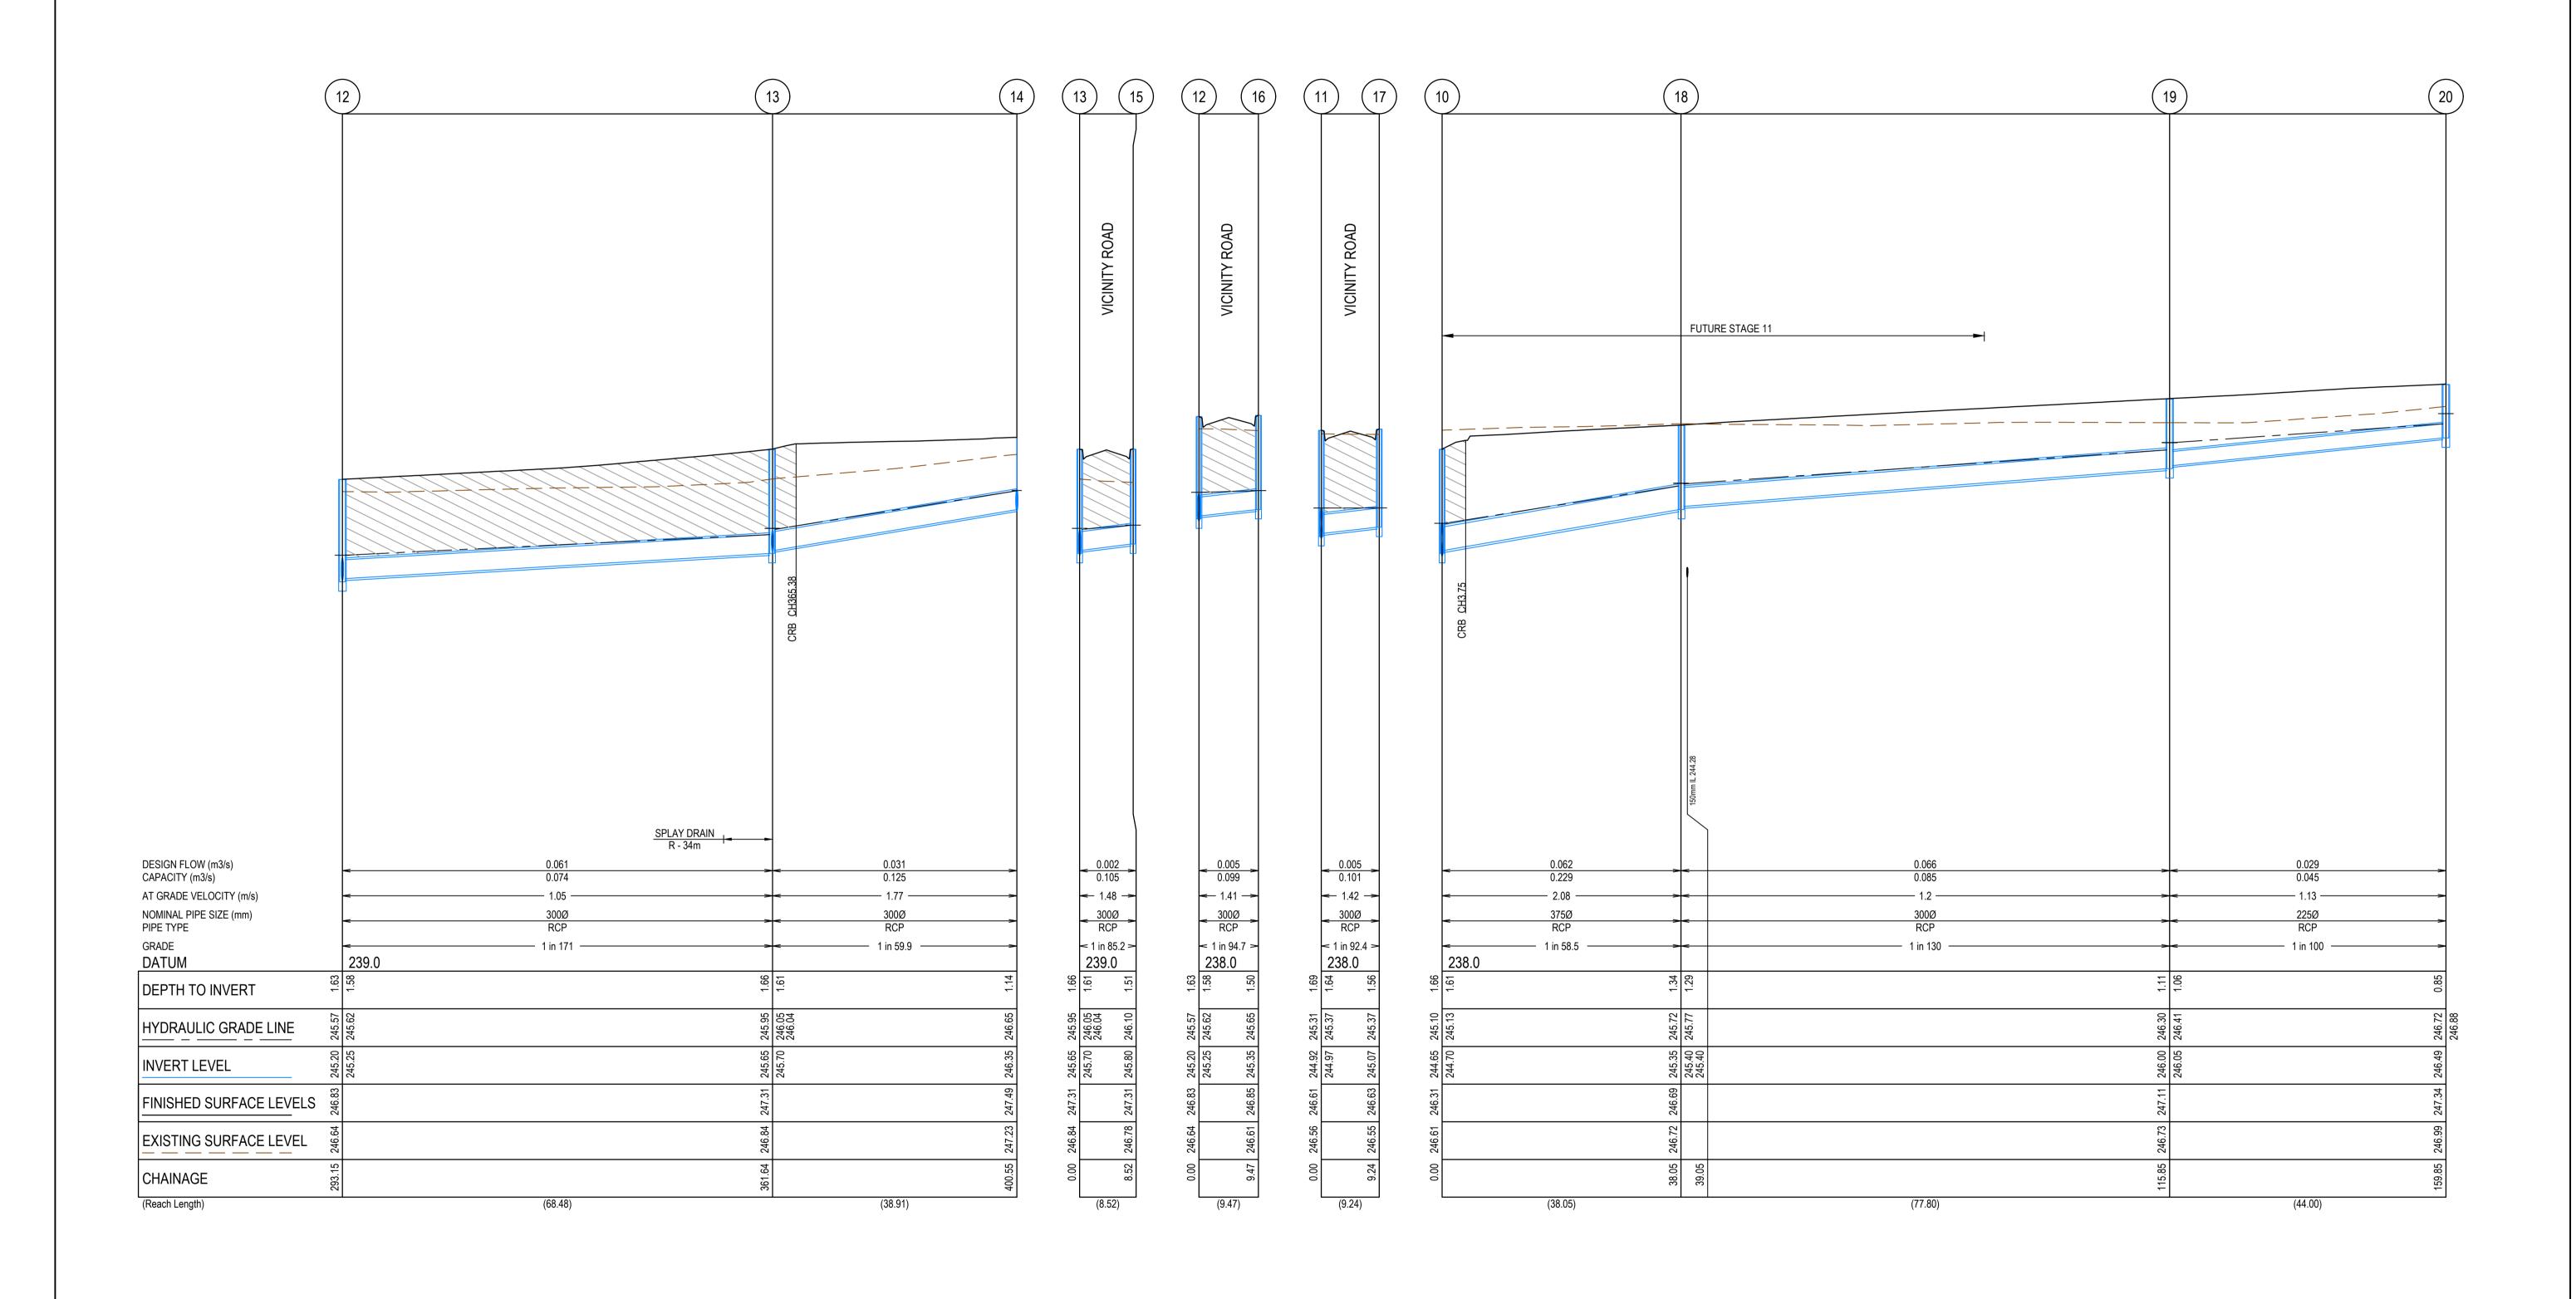


REV	DATE	AMENDMENT / REVISION DESCRIPTION	DES/DFT	APPROVAL	
Α	28.05.19	ISSUED TO COUNCIL FOR APPROVAL	SM/RB	AB	
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All setting out should be carried out in accordance with MPA/Council's standard drawings or as nominated on hard copy plans provided by SMEC. Any digital information supplied by this office is for information only. Any discrepancies should be discussed with the superintendent.



e is for information	DRAFTER	R.Barua
e superintendent.	DESIGNER	P.McKay
Management (501400)	CHECKED	Z.Gosev
10 02	AUTHORISED	A.Burrows
4001	COUNCIL DRAWING REF.	
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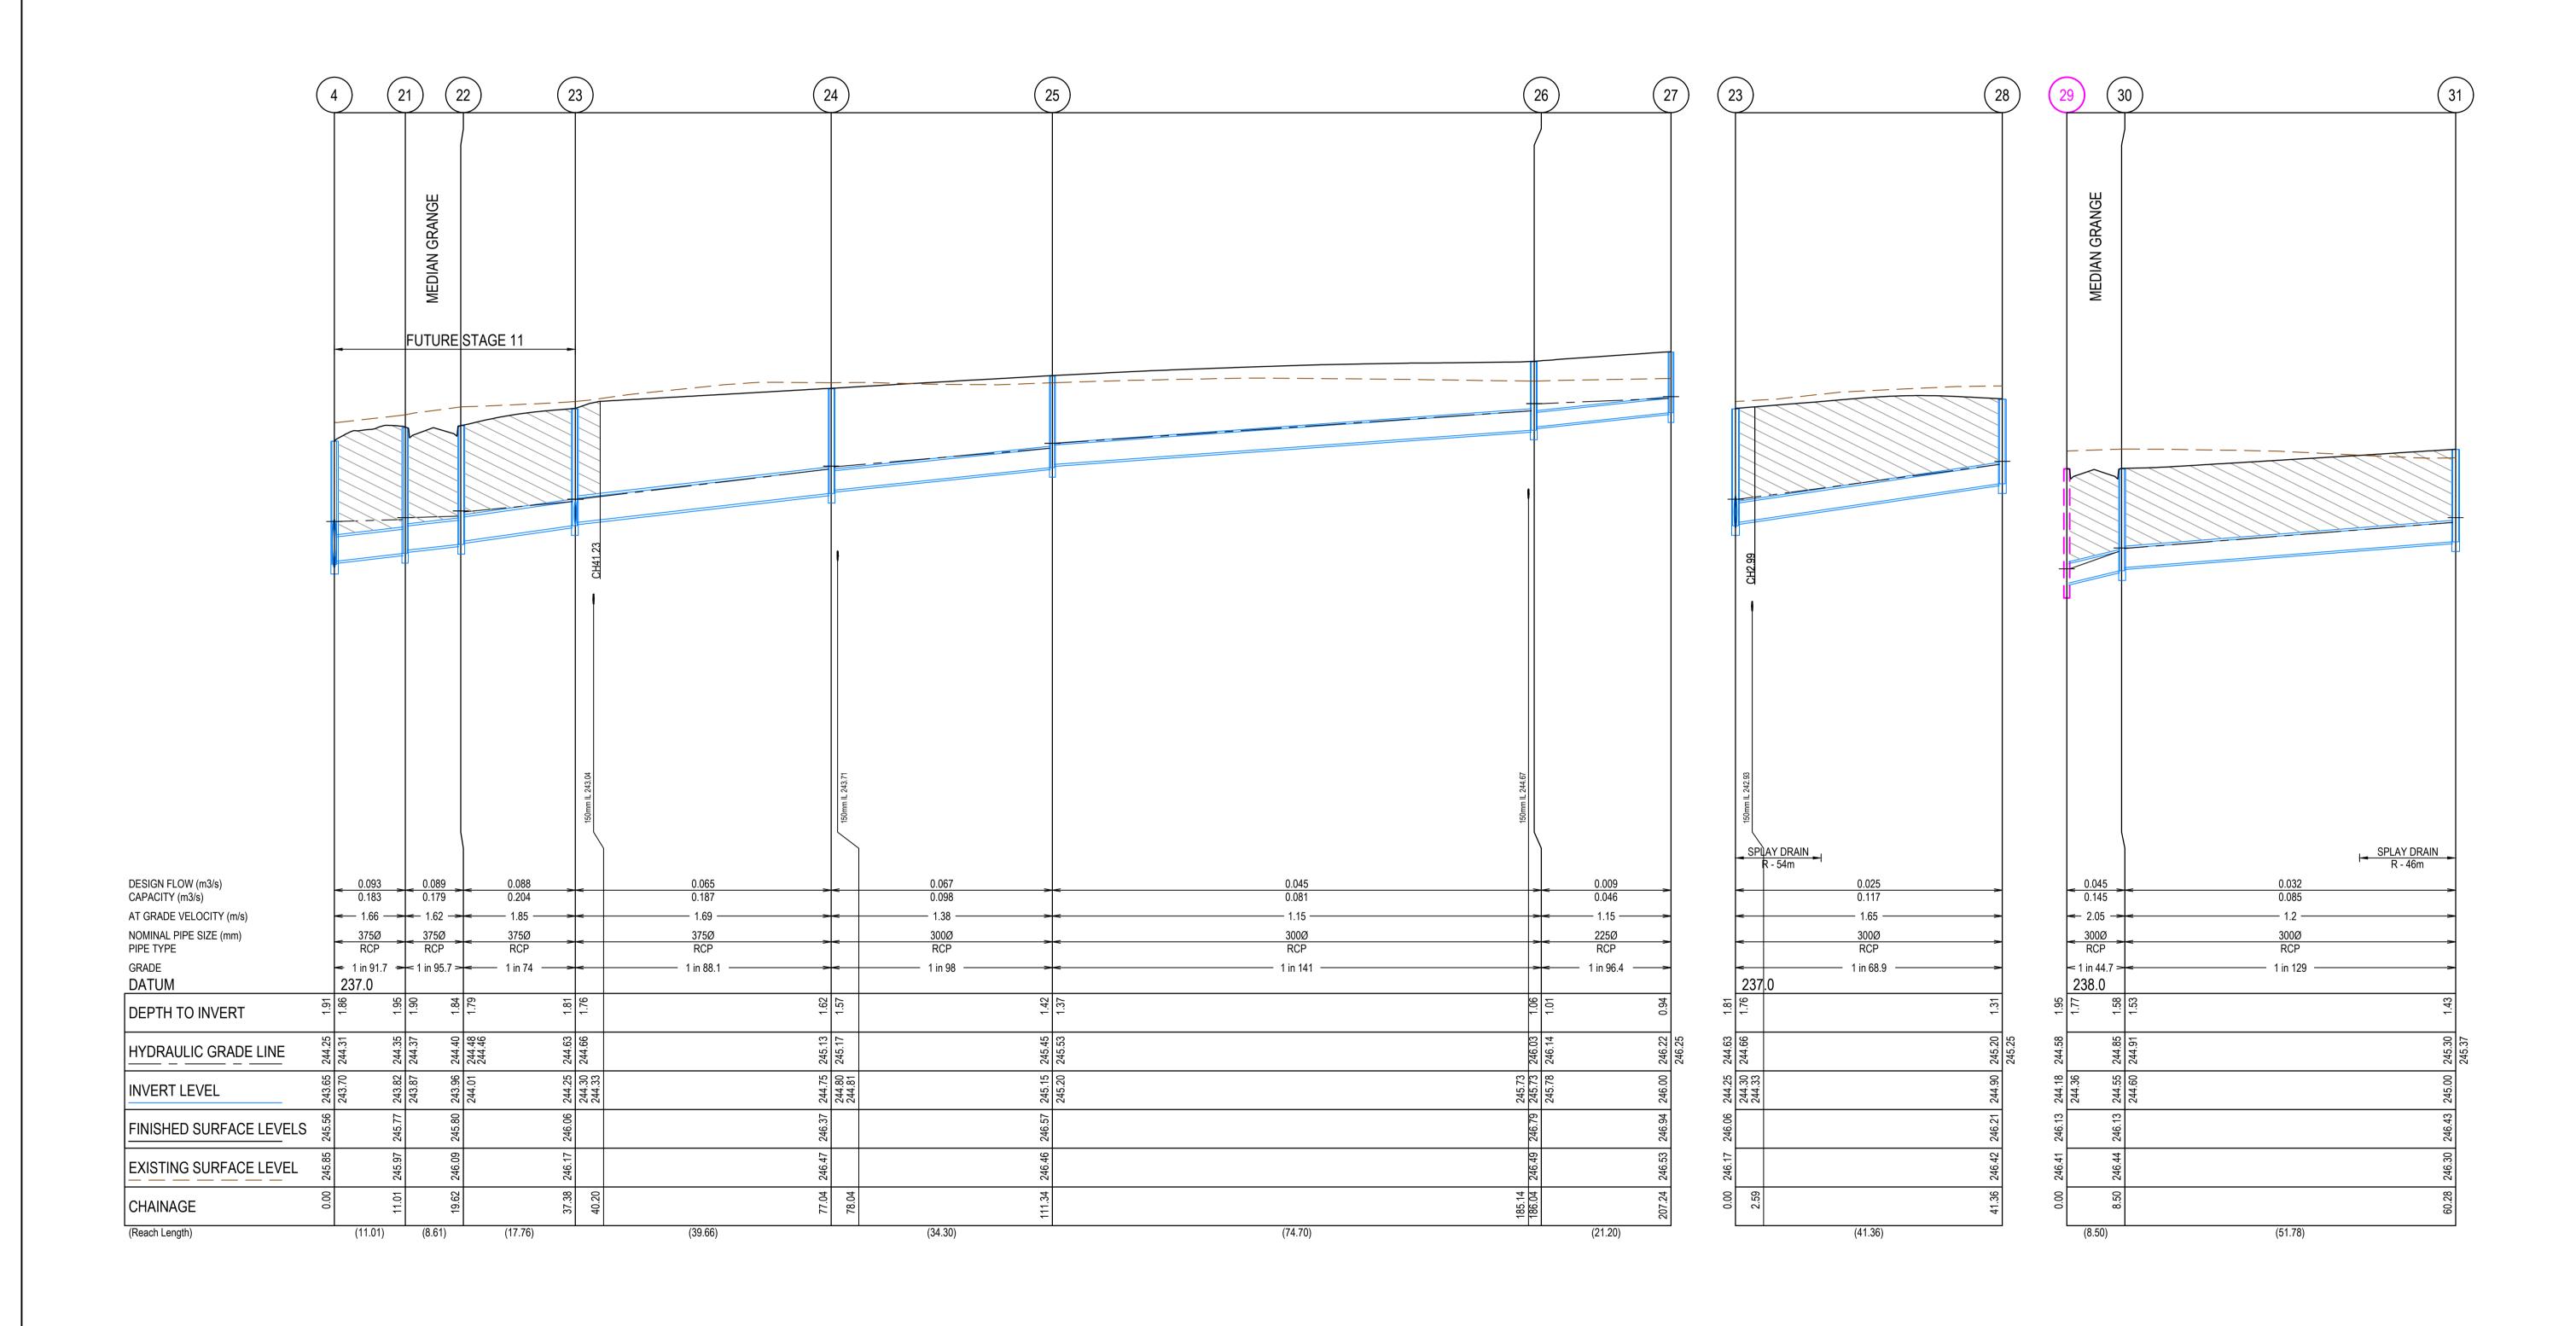
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Olivine Estate - Stage 10
Whittlesea City Council
Road and Drainage
Drainage Longitudinal Sections - 2

MELWAYS REF PROJECT / DRAWING No. SHEET No. REVISION A 12 of 20 A

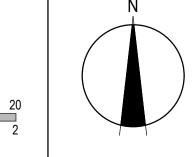

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AMENDMENT / REVISION DESCRIPTION

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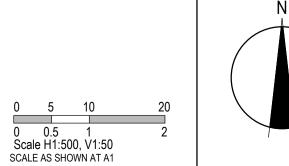


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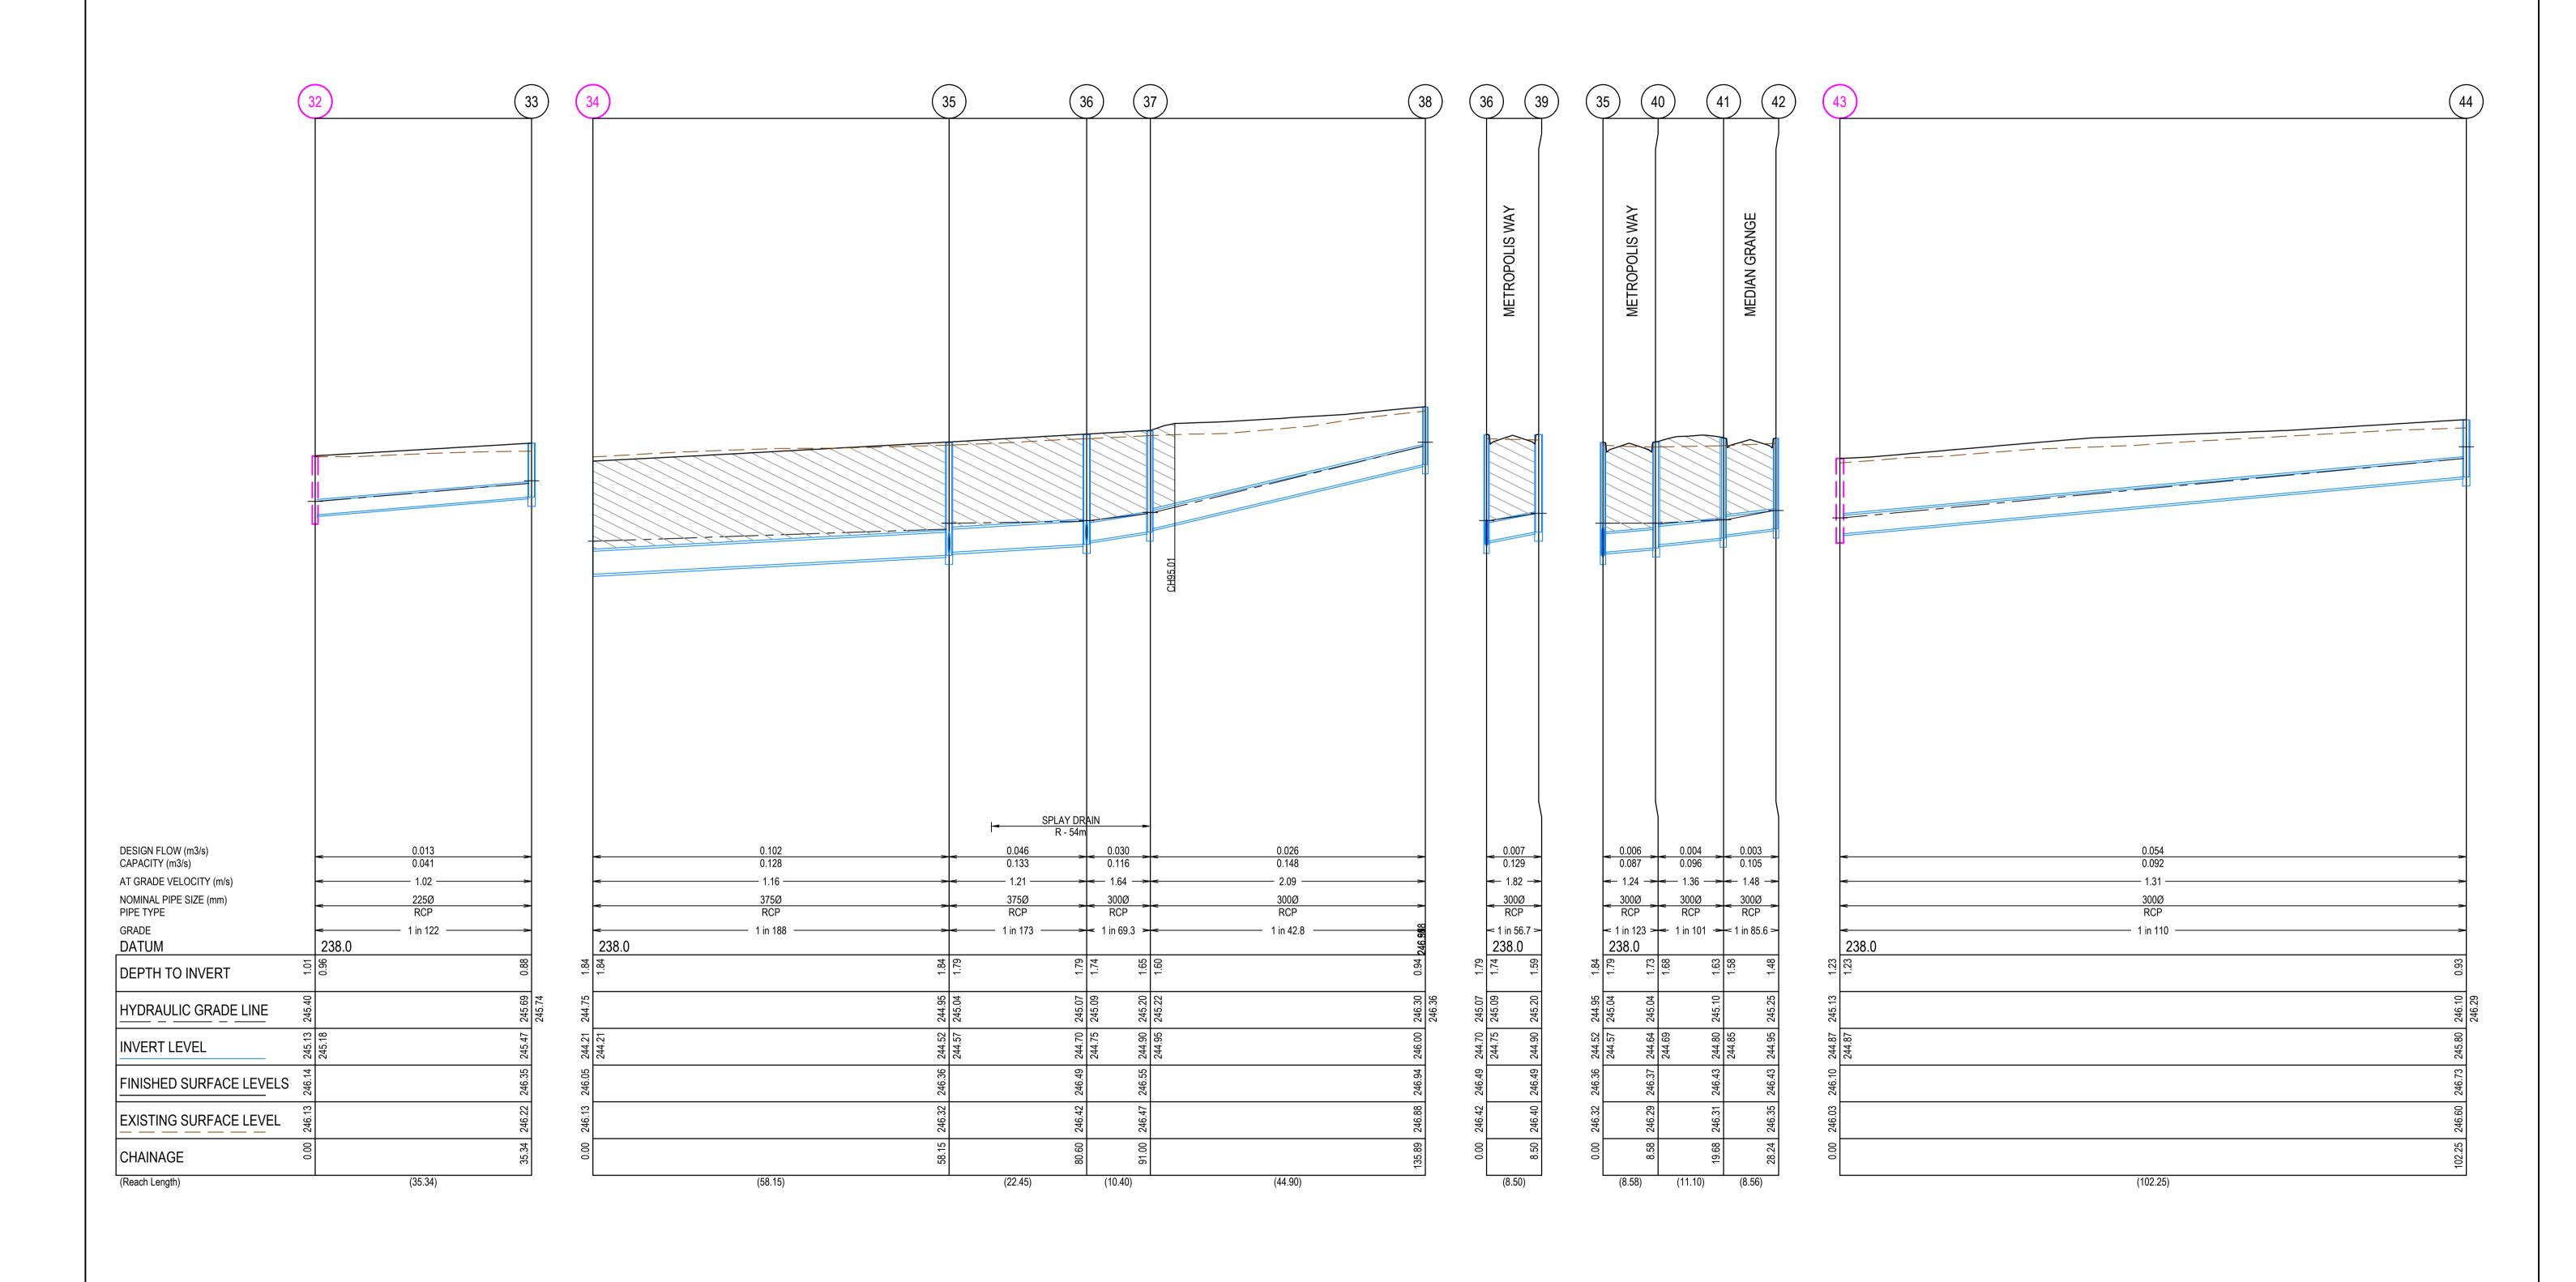




Olivine Estate - Stage 10
Whittlesea City Council
Road and Drainage
Drainage Longitudinal Sections - 3

MELWAYS REF PROJECT / DRAWING No. 1700E-10-13

SHEET No. REVISION A





REV	DATE	AMENDMENT / REVISION DESCRIPTION	DES/DFT	APPROVAL	
A	28.05.19	ISSUED TO COUNCIL FOR APPROVAL	SM/RB	AB	

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Olivine Estate - Stage 10
Whittlesea City Council
Road and Drainage
Drainage Longitudinal Sections - 4

MELWAYS REF PROJECT / DRAWING No. 1700E-10-14

SHEET No. REVISION A

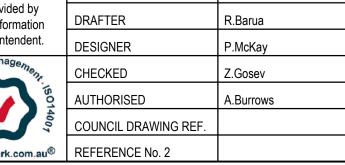DIT 100	-	INTERNAL		INLET		ОИТ	LET		DEDTH	STANDARD	
PIT NUMBER	TYPE	WIDTH (mm)	LENGTH (mm)	DIAMETER (mm)	INV R.L. (m)	DIAMETER (mm)	INV R.L. (m)	PIT SETOUT R.L.	DEPTH	DRAWING	REMARKS
1	Ex PIT	900	900	600	242.85			244.58			CONNECT TO EXISTING PIT
2	JUNCTION PIT	1050	900	600	243.1	600	243.05	244.93	1.88	EDCM 607	HAUNCH PIT. COVER 600 x 900
3	JUNCTION PIT	900	900	600	243.25	600	243.2	245.2	2	EDCM 607	HAUNCHED PIT UNDER KERB. COVER 600 X 900
				300	243.6						
4	JUNCTION PIT	750	900	600	243.7	600	243.65	245.56	1.91	EDCM 607	HAUNCH PIT. COVER 600 x 900
				375	243.7						
5	JUNCTION PIT	750	900	600	243.9	600	243.85	245.71	1.86	EDCM 607	HAUNCH PIT. COVER 600 x 900. PROVIDE GRATED JUNCTION PIT LID. REFER DE
				300	243.9						
6	JUNCTION PIT	750	900	525	244.08	600	244.03	245.86	1.83	EDCM 607	HAUNCH PIT. COVER 600 x 900
				375	244.08						
7	JUNCTION PIT	750	900	525	244.3	525	244.25	246.08	1.83	EDCM 607	HAUNCH PIT. COVER 600 x 900
				300	244.27						
8	JUNCTION PIT	600	900	525	244.4	525	244.35	246.15	1.8	EDCM 605	
9	JUNCTION PIT	600	900	450	244.5	525	244.45	246.15	1.7	EDCM 605	PROVIDE GRATED JUNCTION PIT LID. REFER DETAIL
10	JUNCTION PIT	600	900	375	244.7	450	244.65	246.31	1.66	EDCM 605	THO VIDE GRATED CONCITON THE EID. HET EN DETAIL
10	JONGHON FII	000	300	375	244.7	430	244.00	240.31	1.00	EDOW 003	
11	GRATED ENTRY PIT	600	900	375	244.7	375	244.92	246.61	1.69	EDCM 605 & 601	
11	GRATED ENTRY PIT	000	900			313	<u> </u>	240.01	۲.05 	[DO & COO INIOUS	
40	ODATED ENTRY DIT	000	000	300	244.97	075	045.0	040.00	4.00	EDOM COS O CO	
12	GRATED ENTRY PIT	600	900	300	245.25	375	245.2	246.83	1.63	EDCM 605 & 601	
		200	200	300	245.25		0.45.05	0.17.04	4.00		
13	GRATED ENTRY PIT	600	900	300	245.7	300	245.65	247.31	1.66	EDCM 605 & 601	
				300	245.7						
14	ENDPIPE			300	246.35	300	246.35	247.49	1.14		BLANK OFF END PIPE
15	GRATED ENTRY PIT	600	900			300	245.8	247.31	1.51	EDCM 605 & 601	
16	GRATED ENTRY PIT	600	900			300	245.35	246.85	1.5	EDCM 605 & 601	
17	GRATED ENTRY PIT	600	900			300	245.07	246.63	1.56	EDCM 605 & 601	
18	JUNCTION PIT	600	900	300	245.4	375	245.35	246.69	1.34	EDCM 605	
19	JUNCTION PIT	600	900	225	246.05	300	246	247.11	1.11	EDCM 605	PROVIDE GRATED JUNCTION PIT LID. REFER DETAIL
20	JUNCTION PIT	600	900			225	246.49	247.34	0.85	EDCM 605	
21	JUNCTION PIT	600	900	375	243.87	375	243.82	245.77	1.95	EDCM 605	
22	JUNCTION PIT	600	900	375	244.01	375	243.96	245.8	1.84	EDCM 605	
23	JUNCTION PIT	600	900	375	244.3	375	244.25	246.06	1.81	EDCM 605	
				300	244.3						
24	JUNCTION PIT	600	900	300	244.8	375	244.75	246.37	1.62	EDCM 605	
25	JUNCTION PIT	600	900	300	245.2	300	245.14	246.57	1.42	EDCM 605	
26	JUNCTION PIT	600	900	225	245.78	300	245.73	246.79	1.06	EDCM 605	
27	JUNCTION PIT	600	900			225	246	246.94	0.94	EDCM 605	
28	GRATED ENTRY PIT	600	900			300	244.9	246.21	1.31	EDCM 605 & 601	
29	Ex PIT	600	900	300	244.36			246.13			CONNECT TO EXISTING PIT. CONVERT LID TO DGEP
30	DOUBLE GRATED ENTRY PIT	600	900	300	244.6	300	244.55	246.13	1.58	EDCM 605 & 602	
31	GRATED ENTRY PIT	600	900			300	245	246.43	1.43	EDCM 605 & 601	
32	Ex PIT	600	900	225	245.18			246.14			CONNECT TO EXISTING PIT.
33	GRATED ENTRY PIT	600	900			225	245.47	246.35	0.88	EDCM 605 & 601	
34	Ex ENDPIPE			375	244.21			246.05			CONNECT TO EXISTING PIPE.
35	GRATED ENTRY PIT	600	900	375	244.57	375	244.52	246.36	1.84	EDCM 605 & 601	
				300	244.57	1.0	_ · · · • •	,		J 000 00 00 1	
36	GRATED ENTRY PIT	600	900	300	244.75	375	244.7	246.49	1.79	EDCM 605 & 601	
	OWNED ENTRY FIL	000	300	300	244.75	010	477.I	270.7∂	1.13		
37	GRATED ENTRY PIT	600	900	300	244.75	300	244.9	246.55	1.65	EDCM 605 & 601	
			900	300	∠ 44 .30						
38	JUNCTION PIT	600				300	246	246.94	0.94	EDCM 605	
39	GRATED ENTRY PIT	600	900		A	300	244.9	246.49	1.59	EDCM 605 & 601	
40	GRATED ENTRY PIT	600	900	300	244.69	300	244.64	246.37	1.73	EDCM 605 & 601	
41	GRATED ENTRY PIT	600	900	300	244.85	300	244.8	246.43	1.63	EDCM 605 & 601	
42	DOUBLE GRATED ENTRY PIT	600	900			300	244.95	246.43	1.48	EDCM 605 & 602	
43	Ex PIT	600	900	300	244.87			246.1			CONNECT TO EXISTING PIT.
44	JUNCTION PIT	600	900			300	245.8	246.73	0.93	EDCM 605	

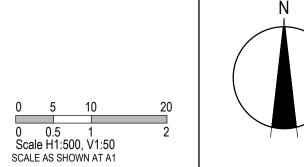SUBJECT	TO	APPROVAL

DATE AMENDMENT / REVISION DESCRIPTION

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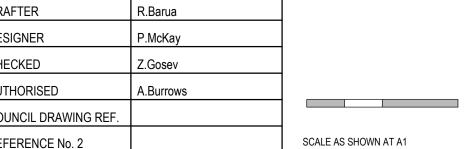



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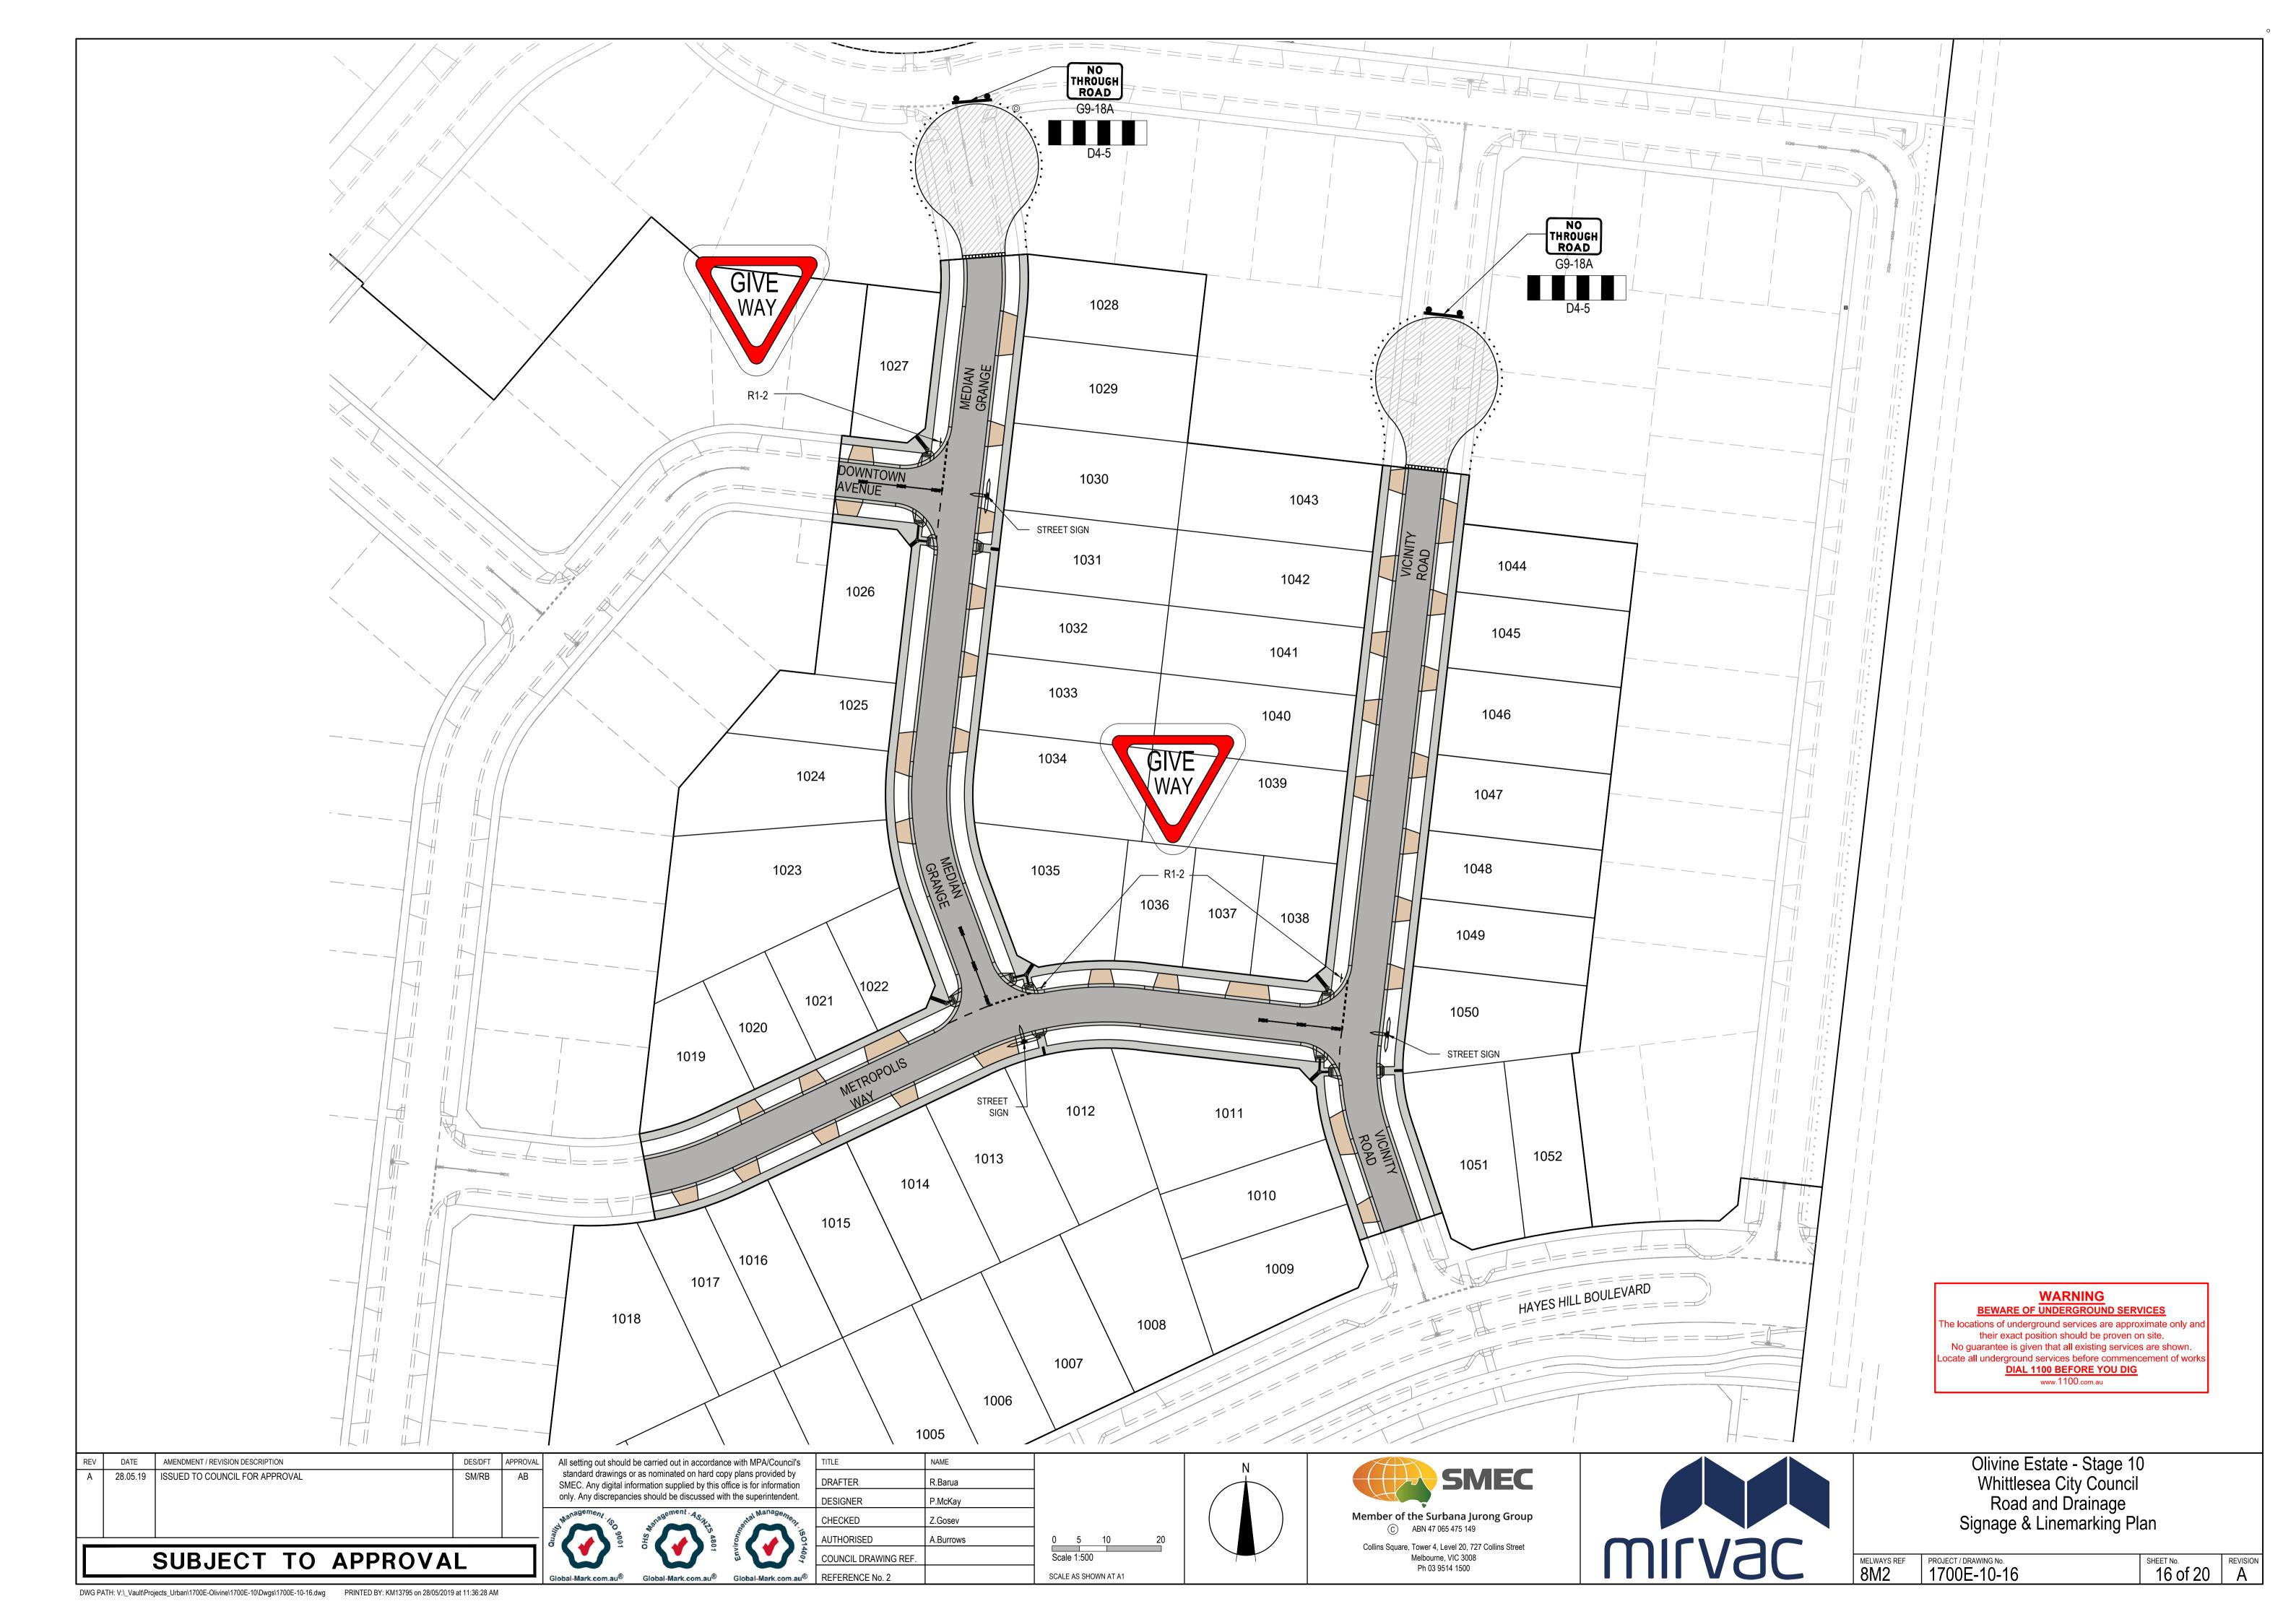









Olivine Estate - Stage 10 Whittlesea City Council Road and Drainage Pit Schedule


MELWAYS REF PROJECT / DRAWING No. 1700E-10-15

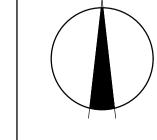


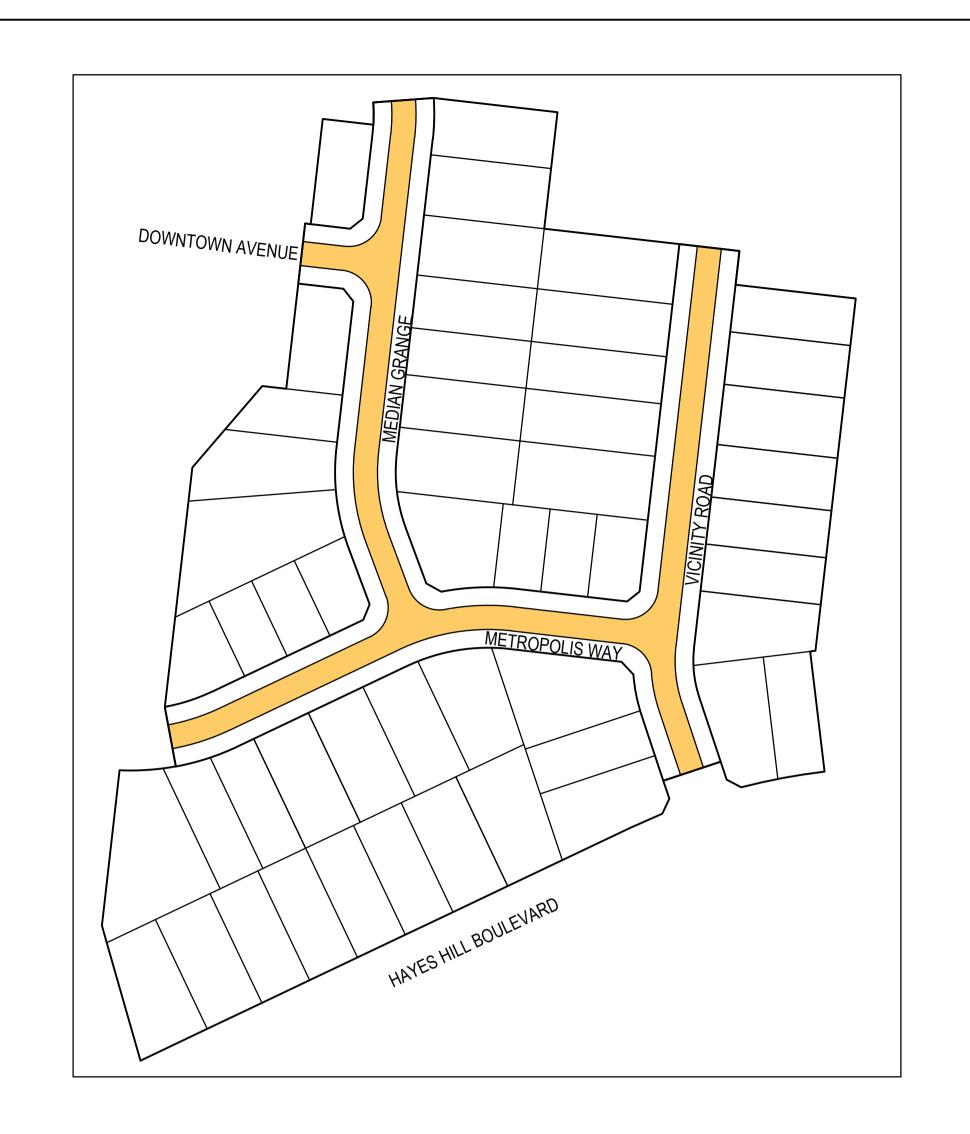

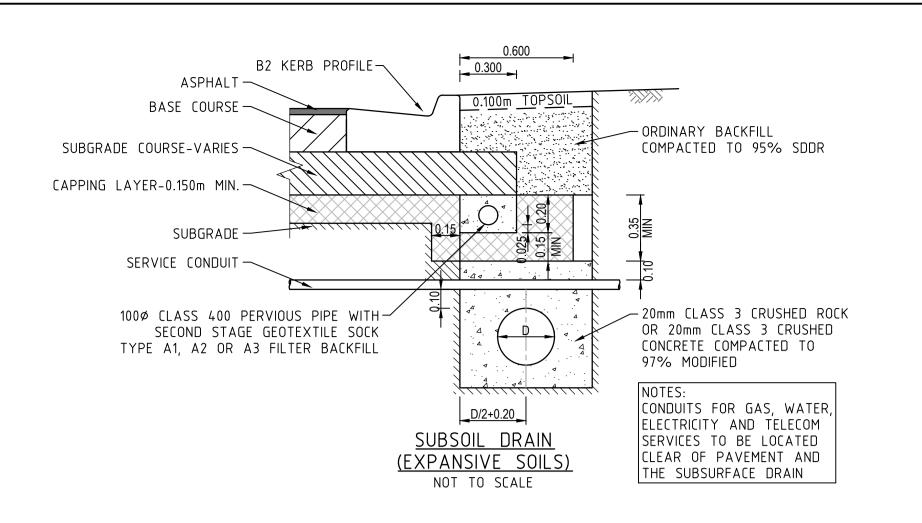


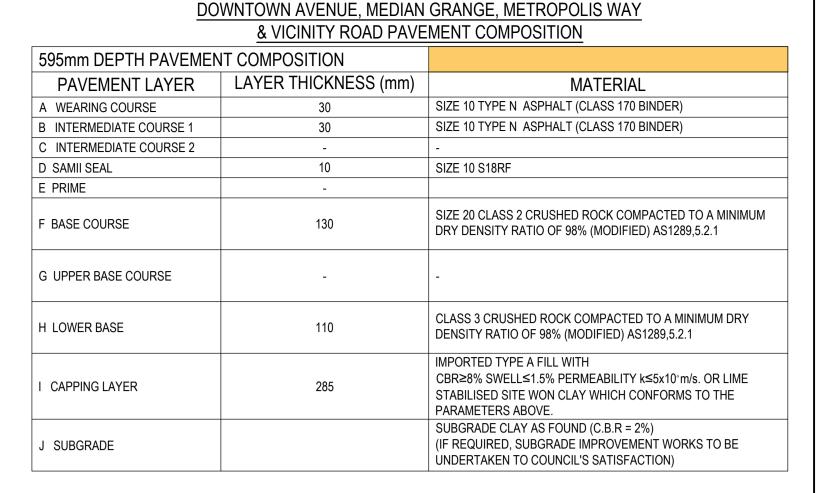

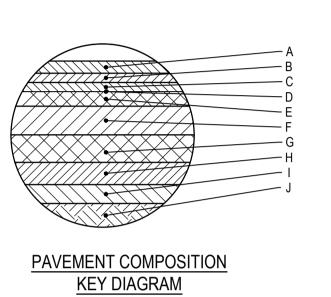


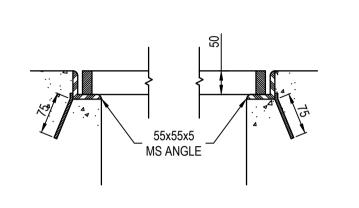

SECTION THROUGH GRATE

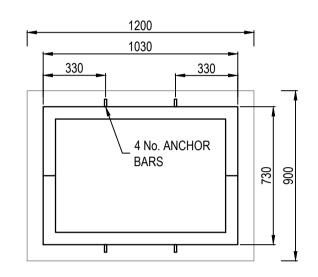



50x12 STRAIGHT BARS 40x10 WAVE BARS **GRATE**

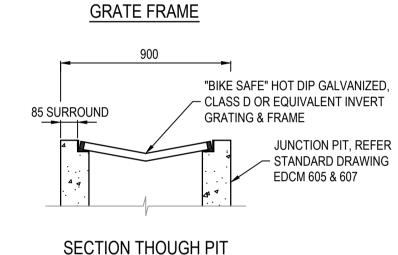


1. REFER TO EDCM STANDARD DRAWINGS 605, 606 & 607 FOR JUNCTION PIT DETAILS 2. GRATE FRAME TO BE "BIKE SAFE" TO AS3996-1992

GRATED JUNCTION PIT DETAIL NOT TO SCALE

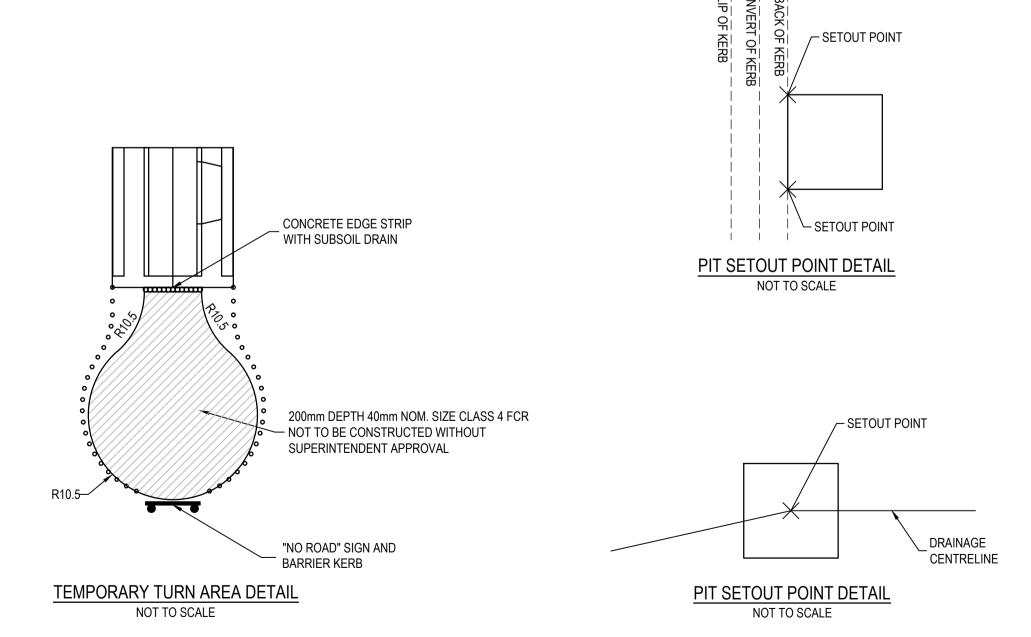

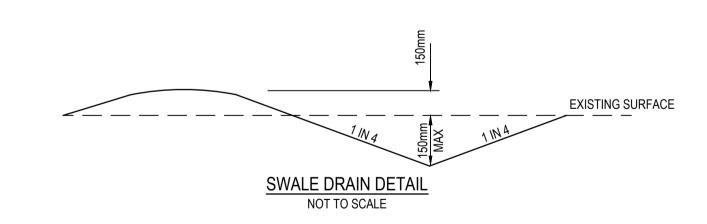

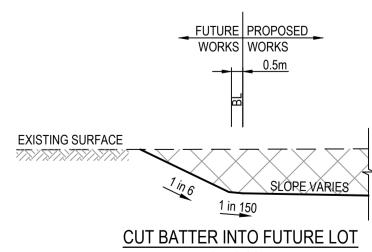


NOT TO SCALE

REV	DATE	AMENDMENT / REVISION DESCRIPTION	DES/DFT	APPROVAL
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1	DRAFTER	R.Barua	
	DESIGNER	P.McKay	
	CHECKED	Z.Gosev	
\\$014007	AUTHORISED	A.Burrows	
4007	COUNCIL DRAWING REF.		
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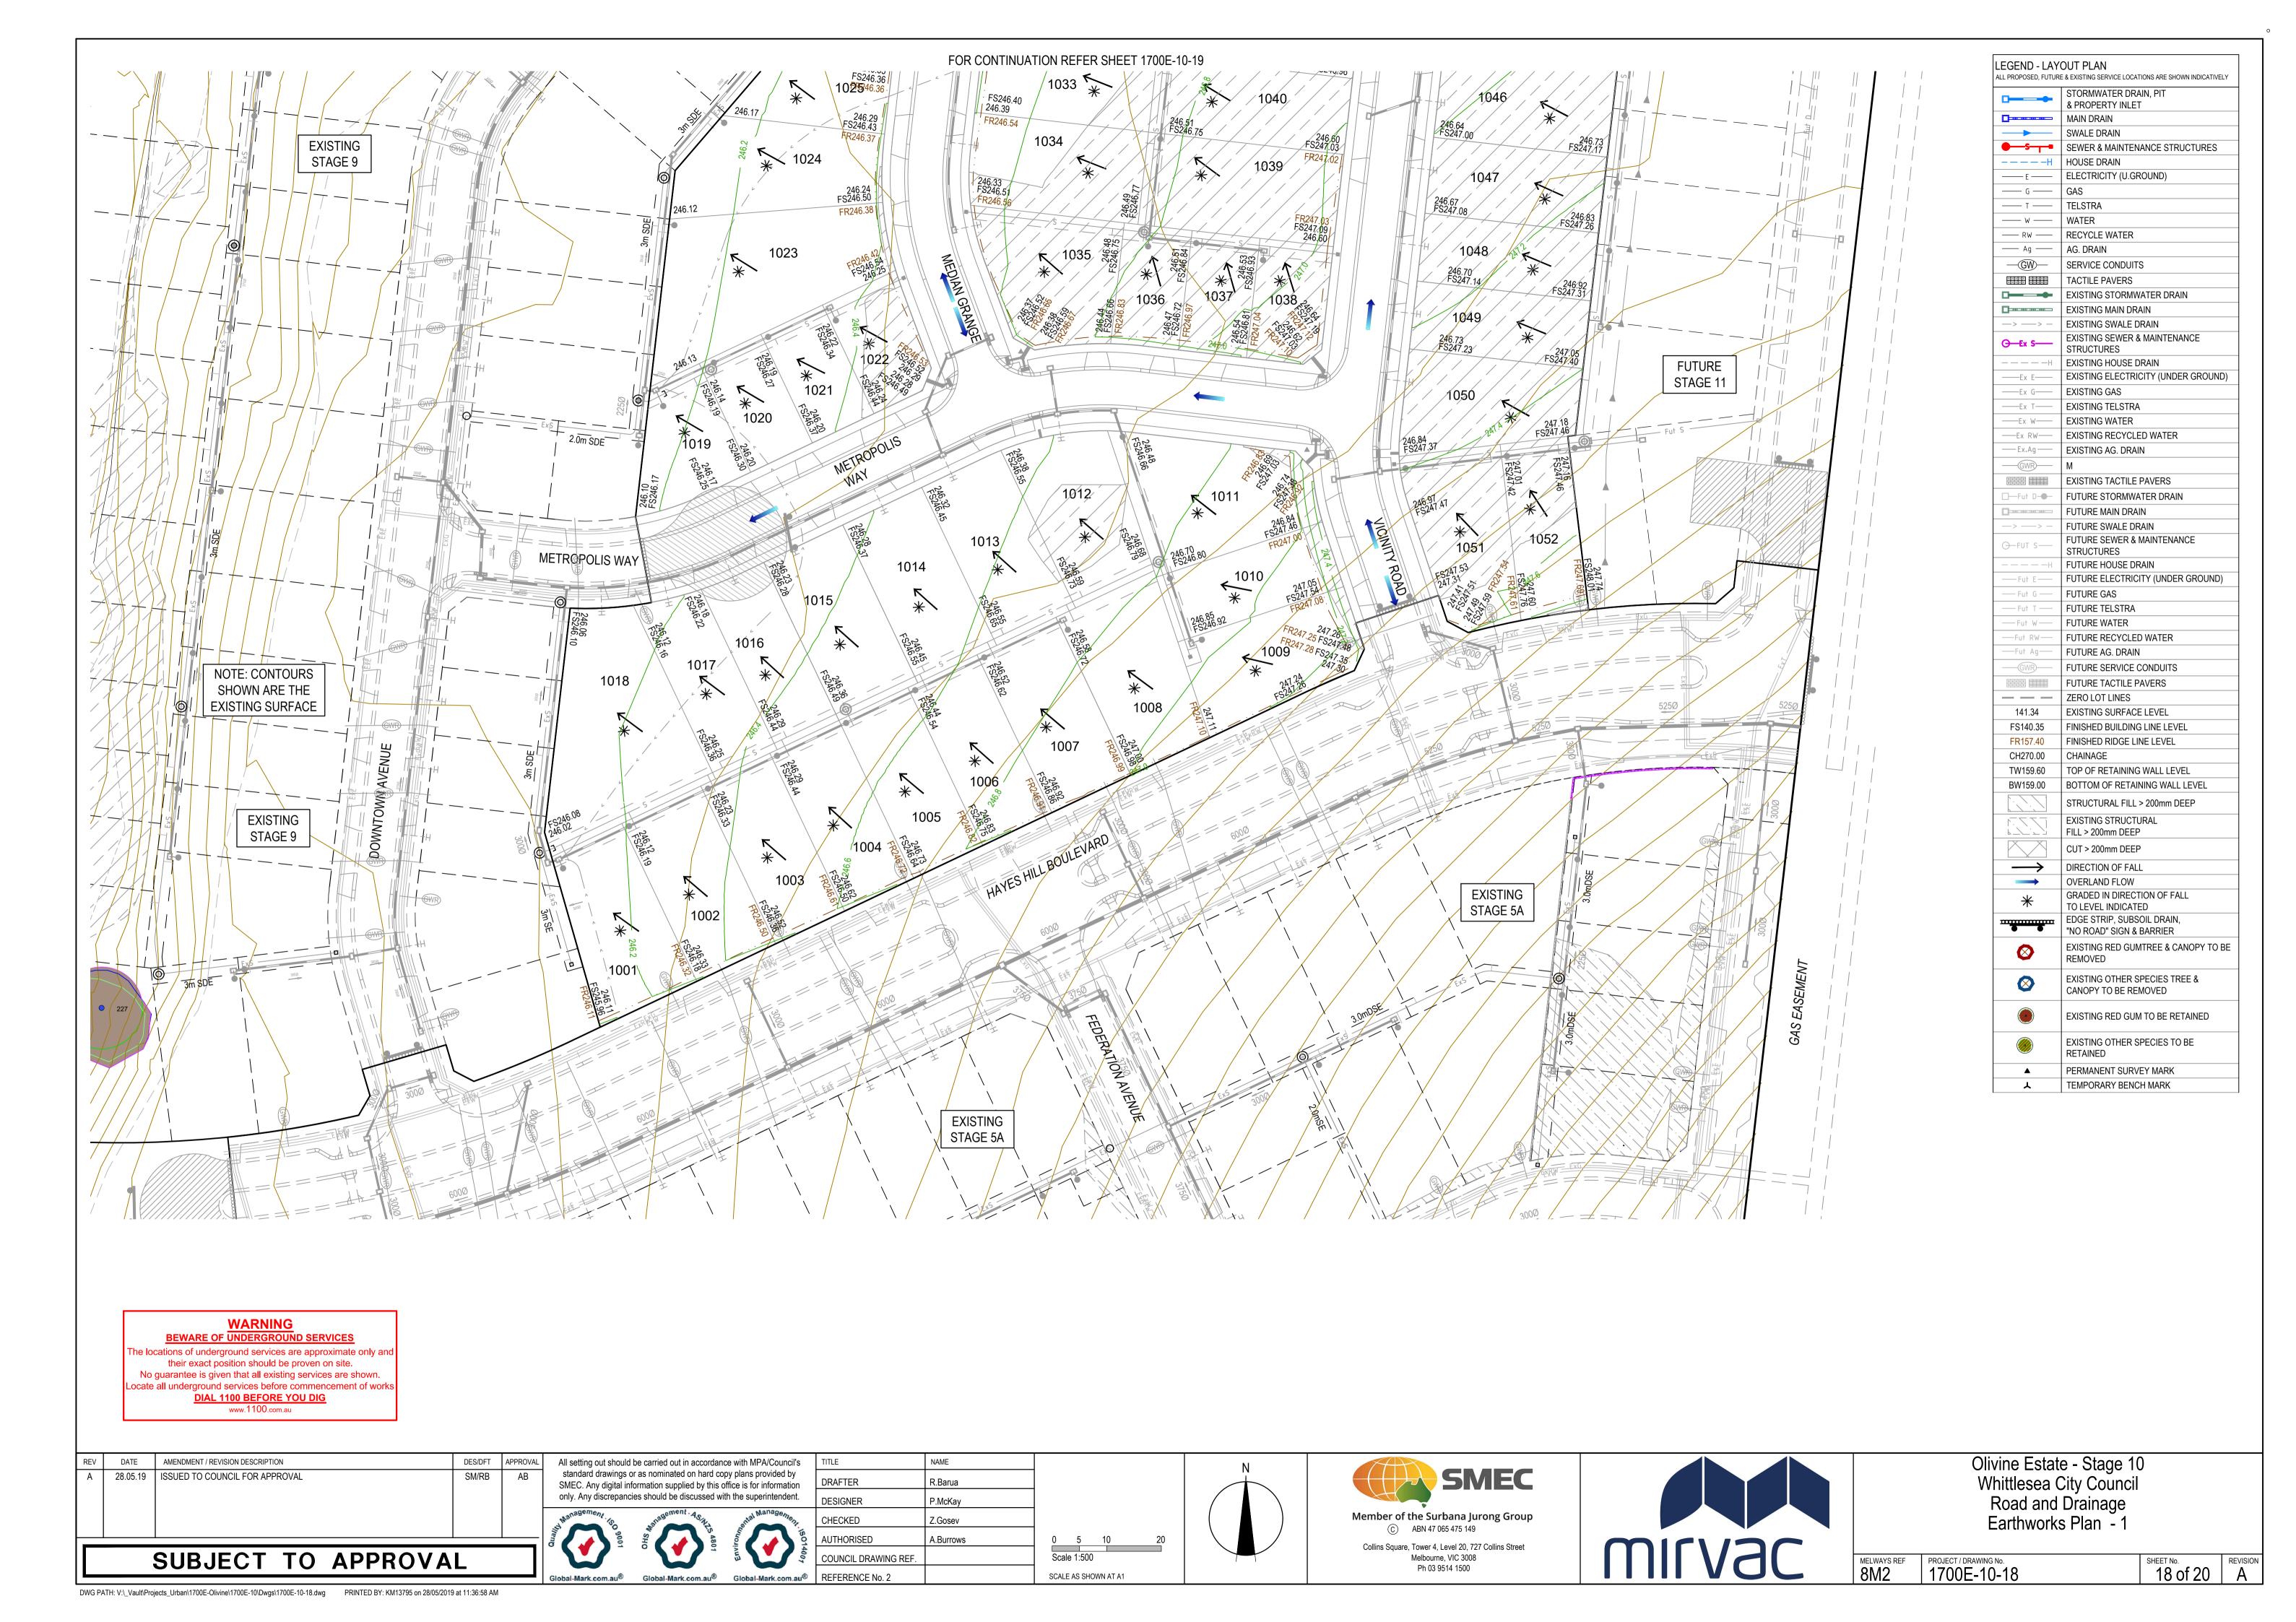







Olivine Estate - Stage 10 Whittlesea City Council Road and Drainage General Notes & Pavement Details

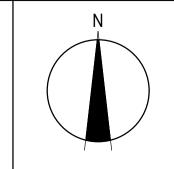PROJECT / DRAWING No. 1700E-10-17 MELWAYS REF SHEET No. REVISION A



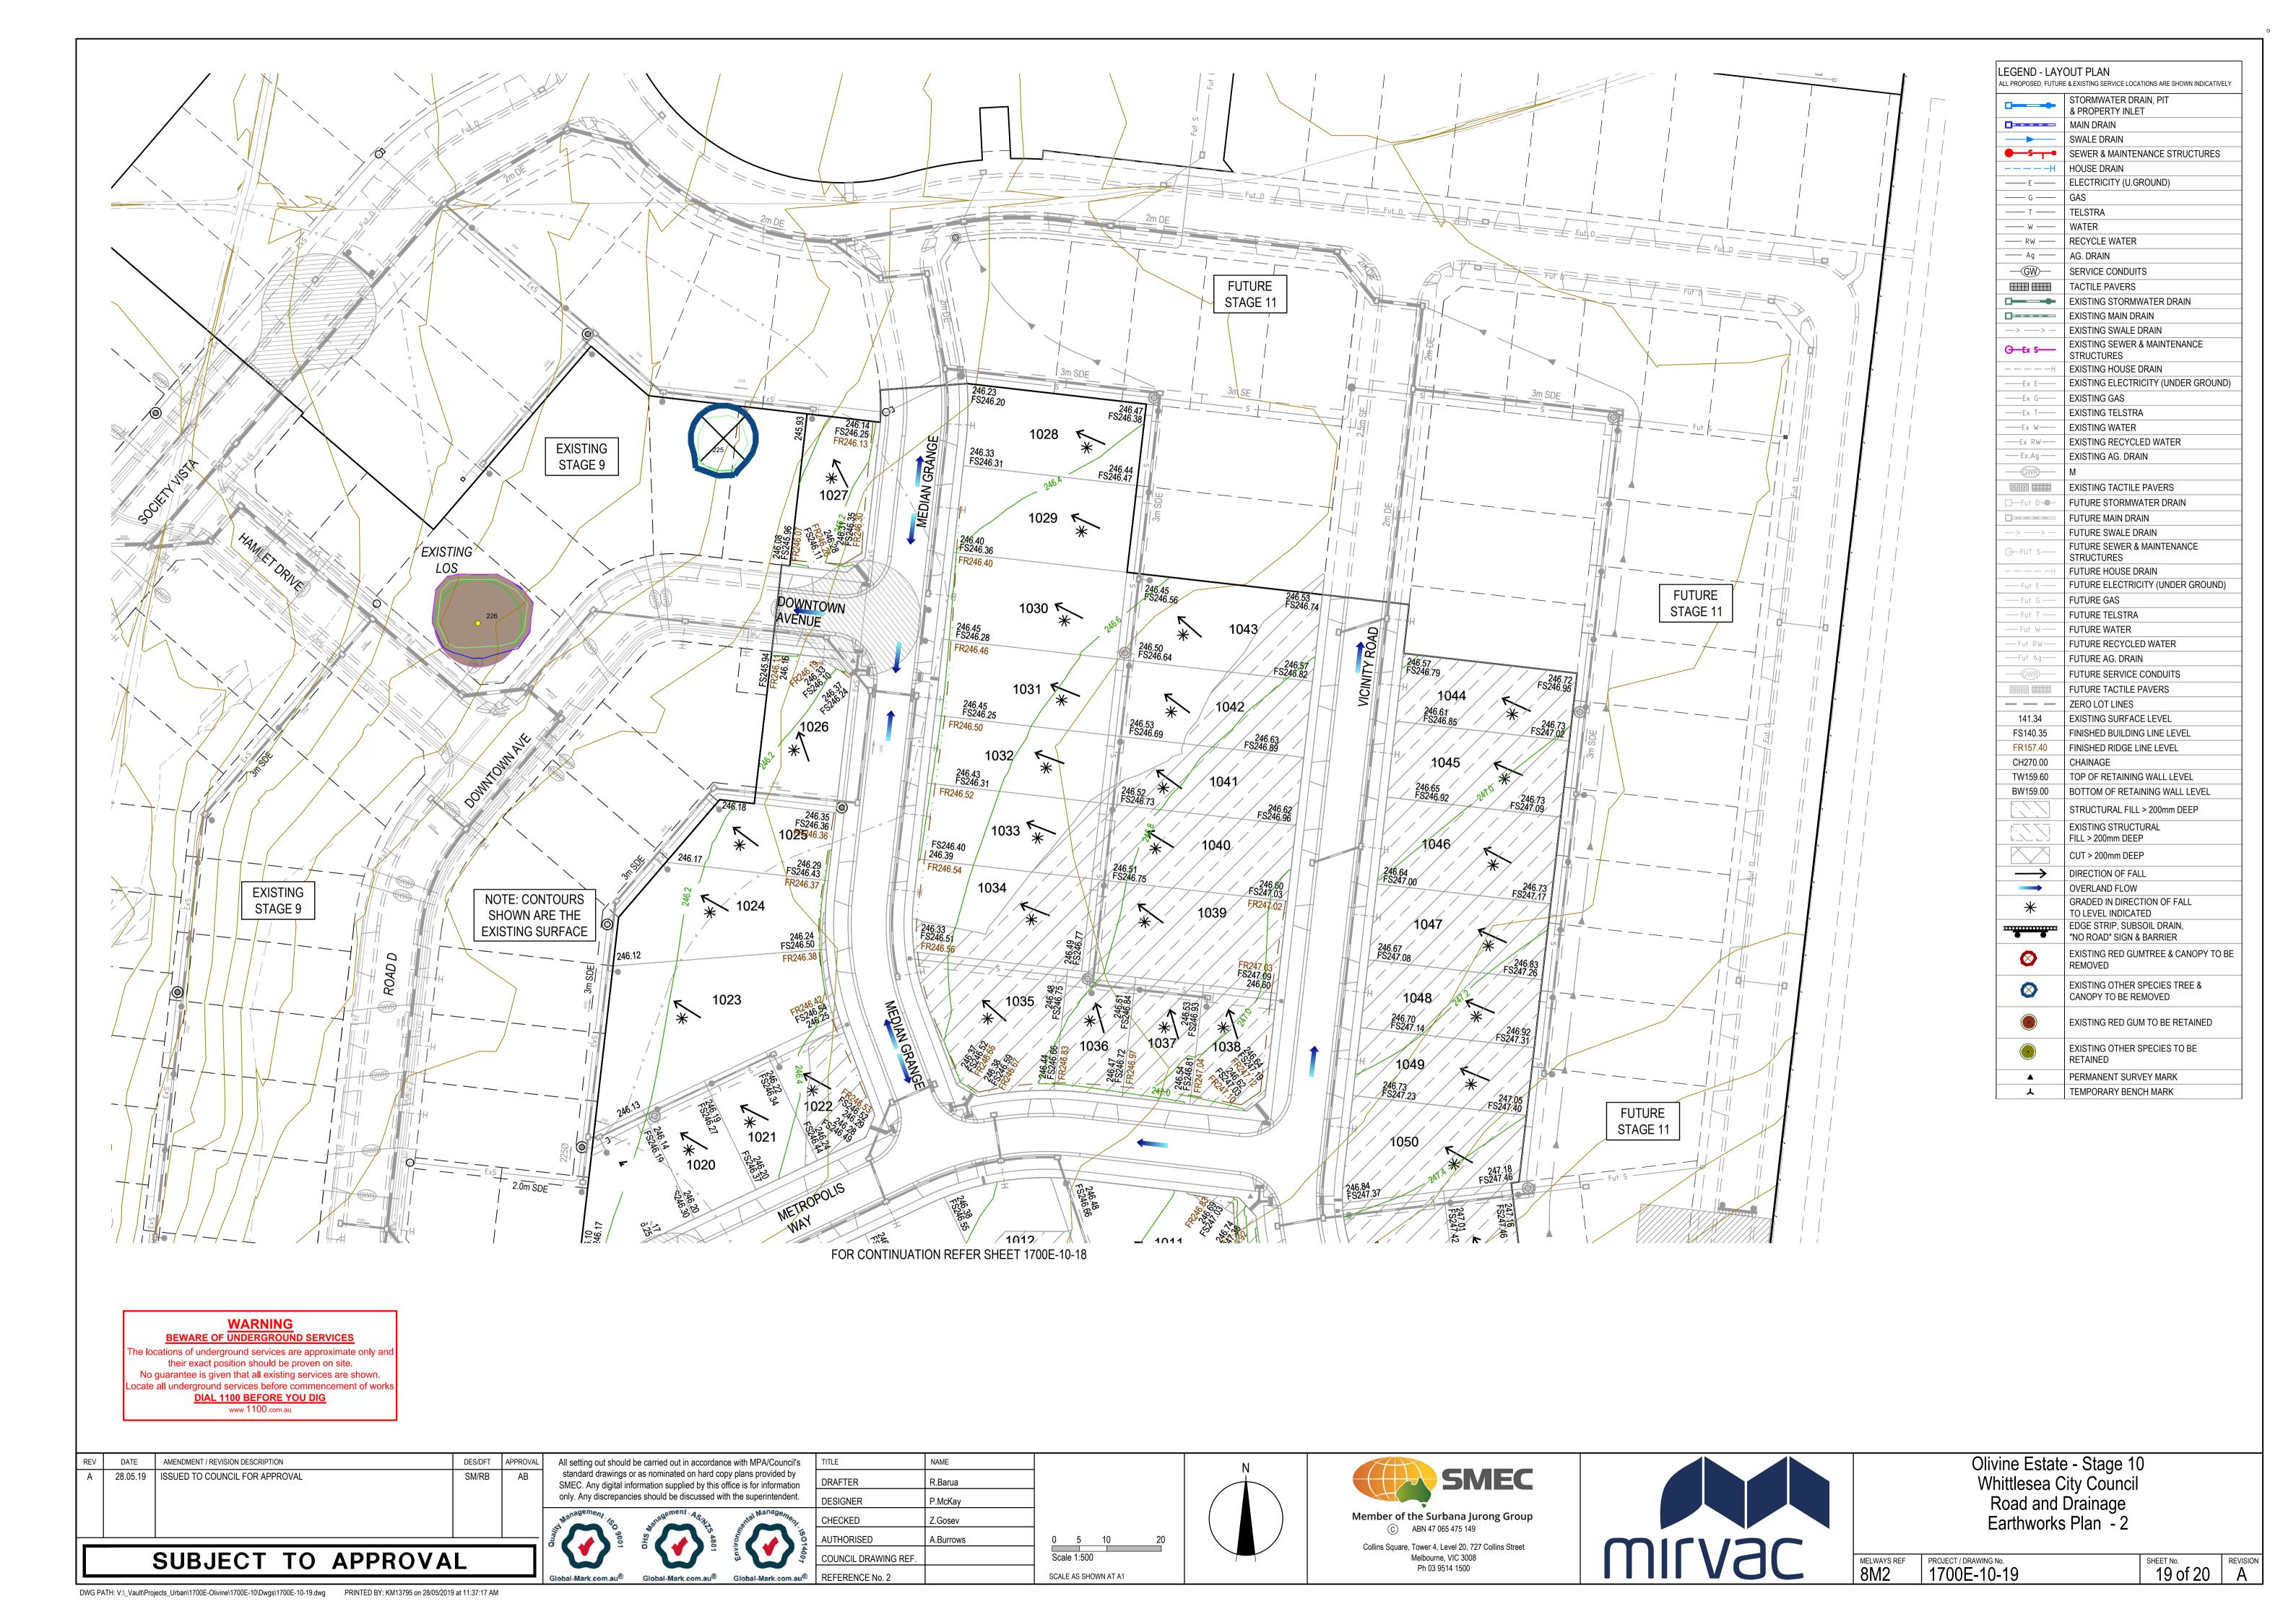

GENERAL NOTES

- ONLY CONTRACTORS ACCREDITED BY YARRA VALLEY WATER TO WC1 SHALL BE ELIGIBLE TO CONSTRUCT
- THESE WORKS. ONLY PRODUCTS APPROVED AND CATALOGUED BY THE WATER AGENCY SHALL BE USED.
- WORKS MUST BE CONSTRUCTED ACCORDING TO WSA 03- 2011 MRWA EDITION.
- THE CONTRACTOR SHALL ENSURE THAT THEY ARE CONVERSANT WITH ALL CURRENT REVISIONS. AMENDMENTS AND UPDATES THAT THE RELEVANT WATER AGENCY HAS MADE TO THEIR STANDARDS.
- DW AND NDW ASSETS SHALL ONLY BE CONSTRUCTED AFTER DEEPER ASSETS AFFECTING THE WATER MAINS HAVE BEEN CONSTRUCTED (EG: SEWERAGE & DRAINAGE ASSETS)
- THIS DESIGN IS TO BE READ IN CONJUNCTION WITH ROAD AND DRAINAGE PLANS.
- 6. THE CONTRACTOR SHALL OBTAIN A ROAD OPENING PERMIT FOR ANY WORKS WITHIN THE ROAD RESERVE AND COMPLY WITH ALL REQUIREMENTS OF THE ROAD OWNER.

SURVEY. SET OUT AND ASSET RECORDING

- TEMPORARY BENCH MARKS (TBM) FOR THE SET OUT OF WORKS TO THE AUSTRALIAN HEIGHT DATUM (AHD) ARE PROVIDED IN THE DESIGN DRAWINGS (SHOWN IN TABLE 6).
- 8. ALL LEVELS ARE IN METRES TO AHD.
- 9. ALL CO-ORDINATES ARE IN METRES TO THE MAP GRID OF AUSTRALIA (MGA 55-94).
- 10. THE CONTRACTOR IS DIRECTLY RESPONSIBLE FOR ENSURING THE PROJECT SET OUT IS CONSISTENT WITH THE DESIGN. SHOULD ACTUAL SITE CONDITIONS CONFLICT IN ANY WAY WITH THAT DOCUMENTED, THE CONTRACTOR SHALL CONTACT THE SUPERINTENDENT FOR CLARIFICATION BEFORE PROCEEDING.
- 11. THE CONTRACTOR IS TO ENGAGE A SUITABLY QUALIFIED AND EXPERIENCED SURVEYOR TO UNDERTAKE ASSET RECORDING OF THE WORK. ALL SURVEYOR WORKS AND DATA RECORDING SHALL BE UNDERTAKEN IN ACCORDANCE WITH THE MRWA SURVEY MANUAL.
- 12. ALL SPECIFIC PIPE MATERIALS (EG: PVC-O) SHALL BE INDICATED IN THE AS CONSTRUCTED INFORMATION

PRODUCTS AND MATERIALS (REFER TABLE 1)

DW AND NDW SYSTEM COMPONENTS SHALL BE DIFFERENTIATED AS PER SECTION 4.2 OF WSA03-2011, MRWA

APPURTENANCES (FITTINGS- REFER TABLE 2)

- 14. ALL VALVES AND HYDRANTS SHALL BE MARKED ACCORDING TO DRAWINGS MRWA-W-300 AND MRWA-W-301 15. VALVE SURROUNDS, COVERS AND SPINDLES SHALL BE CONSTRUCTED IN ACCORDANCE WITH DRAWING
- 16. HYDRANT SURFACE ARRANGEMENTS SHALL BE CONSTRUCTED IN ACCORDANCE WITH DRAWINGS
- MRWA-W-303 17. FLANGE AND FLANGE BOLTS SHALL BE CONSTRUCTED IN ACCORDANCE WITH DRAWINGS MRWA-W-306A AND MRWA-W-306B.
- 18. FOR THE HYDRANT AND WASHOUT DETAILS REFER TO HYDRANT AND WASHOUT SCHEDULE.
- 19. ALL VALVES SHALL BE LOCATED DIRECTLY OUT FROM THE APEX OF THE SPLAY CORNER (UNLESS OTHERWISE

WATER MAIN ALIGNMENT, TRENCHING & COVER (REFER TABLE 4 & 8)

- 20. OFFSETS OF MAINS FROM PROPERTY BOUNDARIES SHALL BE; MIN 600MM (MAINS < DN100) AND MIN 1M (MAINS
- 21. ALL WATER MAINS SHALL PASS OVER DRAINS AND SEWERS UNLESS SHOWN OTHERWISE IN THE DESIGN DRAWINGS

EMBEDMENT

- 22. EMBEDMENT SHALL BE PLACED AS PER DRAWINGS MRWA-W-201 AND MRWA-W-202.
- 23. PIPE EMBEDMENT MATERIALS SHALL BE IN ACCORDANCE WITH PRODUCT SPECIFICATIONS WSA-PS-351, 360 AND 361 AS APPROVED FOR THE MATERIAL AND OR ANY SPECIAL EMBEDMENT.
- 24. SPECIAL EMBEDMENT SHALL BE PLACED AS PER MRWA-W-203.

BACKFILL

- 25. COMPACTION TRIALS AND COMPACTION TESTING SHALL BE UNDERTAKEN IN ACCORDANCE WITH THE MRWA 04-03.1 BACKFILL SPECIFICATIONS.
- 26. TRENCH BACKFILL WITHIN TRAFFICABLE AREAS SHALL BE TO THE ROAD OWNER SPECIFICATION (REFER MRWA-W-201).
- 27. NON TRAFFICABLE BACKFILL SHALL BE COMPLETED AS PER MRWA-W-201 AND THE 04-03.1 MRWA BACKFILL SPECIFICATION.

THRUST RESTRAINT (REFER TABLE 5)

28. THRUST RESTRAINTS HAVE BEEN DESIGNED ON THE BASIS OF THE AHBP (GROUND STRENGTH) NOMINATED IN TABLE 5. THE CONTRACTOR SHALL CONFIRM THE ACTUAL GROUND CONDITIONS AND DISCUSS WITH THE SUPERINTENDENT ANY GROUND CONDITIONS WHICH ARE FOUND TO BE DIFFERENT TO THAT NOMINATED.

PROPERTY SERVICES

DATE

29. NDW PROPERTY SERVICES SHALL ALWAYS BE LOCATED ON THE LEFT OF THE DW PROPERTY SERVICE AS YOU LOOK FROM THE ROAD TO THE FRONT OF THE PROPERTY.

CONNECTIONS (ALL TYPES)

30. ALL PROPERTY SERVICE CONNECTIONS TO NEW RESIDENTIAL RRJ RETICULATION MAINS ARE TO BE COMPLETED USING PRETAPPED CONNECTORS.

OTHER SERVICES (REF-TABLE 4 & 7)

31. TO RECEIVE THE MOST UP TO DATE INFORMATION PRIOR TO CONSTRUCTION, "DIAL BEFORE YOU DIG" SHALL BE UNDERTAKEN TO AID IN THE LOCATION OF OTHER SERVICES. OTHER SERVICES SHALL BE CAREFULLY LOCATED PRIOR TO FULL EXCAVATION AT THE CONTRACTOR'S COST. ANY CLASHES OF PROPOSED NEW WORKS WITH OTHER ASSETS SHALL BE REPORTED TO THE

SUPERINTENDENT IMMEDIATELY FOR CLARIFICATION. 32. CLEARANCES TO OTHER SERVICES SHALL BE AS PER TABLE 7 AND TABLE 5.5 OF WSA03- 2011 MRWA EDITION. THESE CLEARANCES SHALL APPLY TO SURFACE COVERS AS WELL AS UNDERGROUND ASSETS.

EARTHWORKS AND RETAINING WALLS

33. IN AREAS SUBJECT TO EARTHWORKS, CONSTRUCTION OF WATER ASSETS SHALL NOT COMMENCE UNTIL EARTHWORKS AND RETAINING WALLS HAS BEEN COMPLETED UNLESS WRITTEN APPROVAL HAS BEEN GIVEN BY THE WATER AUTHORITY.

TESTING, ASSET ACCEPTANCE AND LIVE CONNECTIONS

AMENDMENT / REVISION DESCRIPTION

23.08.19 ISSUED FOR CONSTRUCTION

- 34. POST CONSTRUCTION ACTIVITIES (OF BOTH DW & NDW) SUCH AS SWABBING, WATER QUALITY TESTING, PRESSURE TESTING AND CHLORINATION SHALL BE CARRIED OUT IN ACCORDANCE WITH WSA03-2011 MRWA EDITION AND THE MRWA WATER QUALITY COMPLIANCE SPECIFICATION.
- ALL TEST RESULTS SHALL BE DOCUMENTED AND REPORTED TO THE SUPERINTENDENT
- 35. THE WATER AGENCY SHALL BE NOTIFIED IN WRITING 2 FULL WORKING DAYS IN ADVANCE OF TESTING BEING UNDERTAKEN.

DES/DFT APPROVAL All setting out should be carried out in accordance with MPA/Council's standard drawings or as nominated on hard copy plans provided by SMEC. Any digital information supplied by this office is for information only. Any discrepancies should be discussed with the superintendent.

EAST

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323210.099

322900.181

323252.295

323038.436

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322654.654

322549.258

322570.163

322595.579

322617.683

322640.995

323276.817

322946.48

322762.605

322900.731

323208.79

322932.732

POINT

C34SSPL

C68PM77L

C75PM50L

C76SSPL

C77RVTRG

C78SSPG

C79SSPL

C80SPKBG

C81SSPL

C82SSPL

C83SSPL

C84RVTRL

C85SSPL

C93SSPL

C104RVTRL

C106SSPL

C107SSPL

C108SSPL

C109SSPL

ME/SM

DRAFTER S.MacLaren DESIGNER M.Esho CHECKED AUTHORISED A.Burrows WATER AUTHORITY REF. 388/3384 SMEC DRAWING REF.

36. BOTH ENDS OF DW AND NDW MAIN TO METER PROPERTY SERVICES SHALL BE INSPECTED BY THE WATER

BEING CARRIED OUT.

CORRECTLY INSTALLED.

CONTRACTOR.

BY THE WATER AGENCY COMPLIANCE OFFICER.

THE LIVE NETWORK BEING UNDERTAKEN.

SHUT DOWN DURATION EXCEED 4 HOURS.

DAYS WITH COMPLETION TO OCCUR NO LATER THAN 4PM.

NECESSARY TO CARRY OUT THE WORK OUTSIDE NORMAL WORKING HOURS..

THE WATER AGENCY SHALL BE NOTIFIED IN WRITING 2 FULL WORKING DAYS IN ADVANCE OF THIS INSPECTION

EACH PROPERTY SERVICE SHALL BE "SQUIRT TESTED". THIS TEST INVOLVES PLACING EACH NETWORK UNDER

BOTH ENDS OF DW-NDW MAIN TO METER PROPERTY SERVICES ARE TO REMAIN EXPOSED UNTIL INSPECTED

PRESSURE SEPARATELY AND ENSURING THAT ONLY THE END OF THE CORRECT PROPERTY SERVICE

37. THE CONTRACTOR'S ITP SHALL INCLUDE PROVISION FOR EACH NDW CONNECTION TO BE SIGNED OFF AS

38. THE WATER AGENCY SHALL BE NOTIFIED IN WRITING 9 FULL WORKING DAYS IN ADVANCE OF CONNECTION TO

SHUT DOWN WORK SHALL BE AS SHORT AS PRACTICAL AND SCHEDULED TO COMMENCE AT 9AM ON WORKING

SHUT DOWNS SHALL BE LIMITED TO 4 HOURS IN DURATION. ARRANGE FOR ALTERNATE SUPPLIES SHOULD THE

IN INDUSTRIAL AND COMMERCIAL AREAS, THE IMPACT ON BUSINESS SHALL BE CONSIDERED AND IT MAY BE

39. VALVES CONNECTING NEW ASSETS TO THE WATER AGENCY'S LIVE SYSTEM SHALL NOT BE OPERATED BY THE

WARNING **BEWARE OF ASBESTOS**

SOME UNDERGROUND SERVICES MAYBE CONSTRUCTED

FROM ASBESTOS CONTAINING MATERIAL. CONTACT THE SUPERINTENDENT FOR INSTRUCTIONS ON HOW TO MANAGE ANY POTENTIAL ASBESTOS HAZARD

FOR THE DURATION OF PROCLAIMED WATER

RESTRICTIONS, THE CONTRACTOR SHALL CONFORM WITH THE RESTRICTIONS AND ANY

OTHER WATER CONSERVATION REQUIREMENTS

IMPOSED BY THE WATER AGENCY.

WARNING BEWARE OF UNDERGROUND SERVICES he locations of underground services are approximate only and

their exact position should be proven on site. No guarantee is given that all existing services are shown.

ocate all underground services before commencement of works **DIAL 1100 BEFORE YOU DIG**

www.1100.com.au

388/3384/61 Locality Plan 388/3384/62 Layout Plan - 1

388/3384/63 YVW STD DWG WQP000-C-0001

TABLE 6: TBM SETOUT TABLE

NORTHING

5842934.15

5842698.35

5842750.808

5842715.378

5842738.371

5842759.893

5842778.237

5842776.01

5842791.748

5842989.303

5843198.908

5843412.157

5843611.461

5842944.336

5843298.043

5842991.952

5843023.612

5843072.045

5843474.686

ELEVATION

238.735

237.616

240.178

236.886

243.696

239.488

238.207

238.428

235.563

236.275

239.115

242.457

239.572

237.989

243.686

238.464

240.323

241.058

243.559

NAME

DESCRIPTION

STEEL STAR PICKET

PERMANENT MARK PM77

PERMANENT MARK PM50

STEEL STAR PICKET

RIVET IN ROCK

STEEL STAR PICKET

STEEL STAR PICKET

SPIKE IN BITUMEN

STEEL STAR PICKET

STEEL STAR PICKET

STEEL STAR PICKET

RIVET IN ROCK

STEEL STAR PICKET

STEEL STAR PICKET

RIVET IN ROCK

STEEL STAR PICKET


STEEL STAR PICKET

STEEL STAR PICKET

STEEL STAR PICKET

Drawing Index

SCALE AS SHOWN AT A1

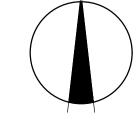



Ph 03 9514 1500



TABLE 2 HYDRANT & WASHOUT SCHEDULE

DESIGN HEAD = 65m (DW & NDW)

TEST PRESSURE = 1000 kPa

POTABLE MAIN

LENGTH (m)

260

RECYCLE MAIN

LENGTH (m)

189

260

ZONE = RESIDENTIAL

CLASS

16

16

16

MAIN SIZE	FITTING TYPE	OWNERSHIP	LOCATION	STREET	LOCATION
100	HYDRANT	NDW-COUNCIL	INLINE	VICINITY ROAD	2.0m N OF SBL OF LOT 1046
100	HYDRANT	NDW-COUNCIL	INLINE	METROPOLIS WAY	2.0m W OF SPLAY LOT 1011
100	HYDRANT	DW	INLINE	METROPOLIS WAY	2.7m W OF SPLAY LOT 1011
100	HYDRANT	NDW-COUNCIL	INLINE	MEDIAN GRANGE	7.0m N OF SPLAY LOT 1035
100	HYDRANT	DW	INLINE	MEDIAN GRANGE	7.7m N OF SPLAY LOT 1035
100	WASHOUT	NDW	PLAIN	VICINITY ROAD	1.0m N OF STG BOUNDARY
100	WASHOUT	DW	PLAIN	VICINITY ROAD	1.0m N OF STG BOUNDARY
100	WASHOUT	NDW	PLAIN	METROPOLIS WAY	1.0m N OF STG BOUNDARY
100	WASHOUT	DW	PLAIN	METROPOLIS WAY	1.0m N OF STG BOUNDARY

TABLE 1 TOTAL WORK SCHEDULE

NEW WORK

TYPE/REFERENCE

"PVC-M WSA-PS-209 PVC-O WSA-PS-210"

PE100 WSA-PS-207

"PE100 (PROPERTY SERVICES) WSA-PS-215"

SIZE (DN)

100

125

25

× ALL DW AND NDW HYDRANTS & WASHOUTS ARE WATER AGENCY OWNED UNLESS STATED OTHERWISE

	TABLE 5: THRUST RESTRAINT SCHEDULE									
LOCATION	TYPE	THRUST	AHBP (kPa) USED	AREA (m2), OR W(m) X Y(m)	NO. LOCATIONS					
В	INLINE	2 x 150x100 TEES & 125 PE SHRINKAGES	50	1.32 (TOT)	1					
С	INLINE	2 x125x125 TEES & 125 PE SHRINKAGES	50	1.32 (TOT)	1					
D	INLINE	2 x 125 PE SHRINKAGES	51	0.86 (TOT)	1					
E	PLAIN	2 x 100 WASHOUTS	50	0.46 (TOT)	2					

S PATE! RIVE **EXISTING** STAGE 5A & B 04

FUTURE HAYES HILL BLVD

EXISTING STAGE

9 AREA

PROPOSED STAGE

10 AREA

TABLE 4: SERVICES OFFSET SCHEDULE										
ROAD NAME	G	GAS		NON-DRINKING WATER		DRINKING WATER		ELECTRICITY		NBN
	SIDE	OFFSET (m)	SIDE	OFFSET (m)	SIDE	OFFSET (m)	SIDE	OFFSET (m)	SIDE	OFFSET (m)
VICINITY ROAD	EAST	2.10	EAST	2.50	EAST	3.00	WEST	2.55	WEST	1.85
METROPOLIS WAY	SOUTH	2.10	SOUTH	2.50	SOUTH	3.00	NORTH	2.55	NORTH	1.85
MEDIAN GRANGE	EAST	2.10	EAST	2.50	EAST	3.00	WEST	2.55	WEST	1.85
DOWNTOWN AVENUE	SOUTH	2.10	SOUTH	2.50	SOUTH	3.00	NORTH	2.35	SOUTH	1.80

TABLE 7: VERTICAL CLEARANCE TABLE MINIMUM VERTICAL EXISTING OR PROPOSED SERVICE CLEARANCE (mm) 150 WATER MAINS ≤DN375 300 WATER MAINS > DN375 150 **GAS MAINS** 150 TELCO CONDUITS & CABLES 225 **ELECTRICITY CONDUITS & CABLES** 150 STORMWATER DRAINS & PITS 500 SEWERS - GRAVITY SEWERS - PRESSURE & VACUUM

- VERTICAL CLEARANCE BETWEEN WATER MAINS SHALL DEPEND ON THE LARGER MAIN DIAMETER. - MAINTAIN ADDITIONAL CLEARANCE FROM HIGH VOLTAGE ELECTRICAL CABLES TO ALLOW FOR A PROTECTIVE BARRIER AND MARKING.

TABLE 8 : PIPE COVER							
LOCATION	MINIMUM COVER						
WITHIN FOOTWAY	450mm						
MINOR/SECONDARY ROADS	600mm						

WARNING SAFETY MEASURES REQUIRED Please note there are risks attached to the construction of this project, and any ongoing maintenance of structures. onsider the safety of all. For potential risks, consequences and controls refer to Safety In Design Risk Register

SID P4.E6. 1700E-10-85

ASSESS THE RISK - STAY SAFE

Yarra Valley Water Whittlesea City Council Olivine Estate - Stage 10


Water Reticulation Plan Locality Plan

PROJECT / DRAWING No. 388/3384/61

MELWAYS REF

01 of 03 | 0

ISSUED FOR CONSTRUCTION

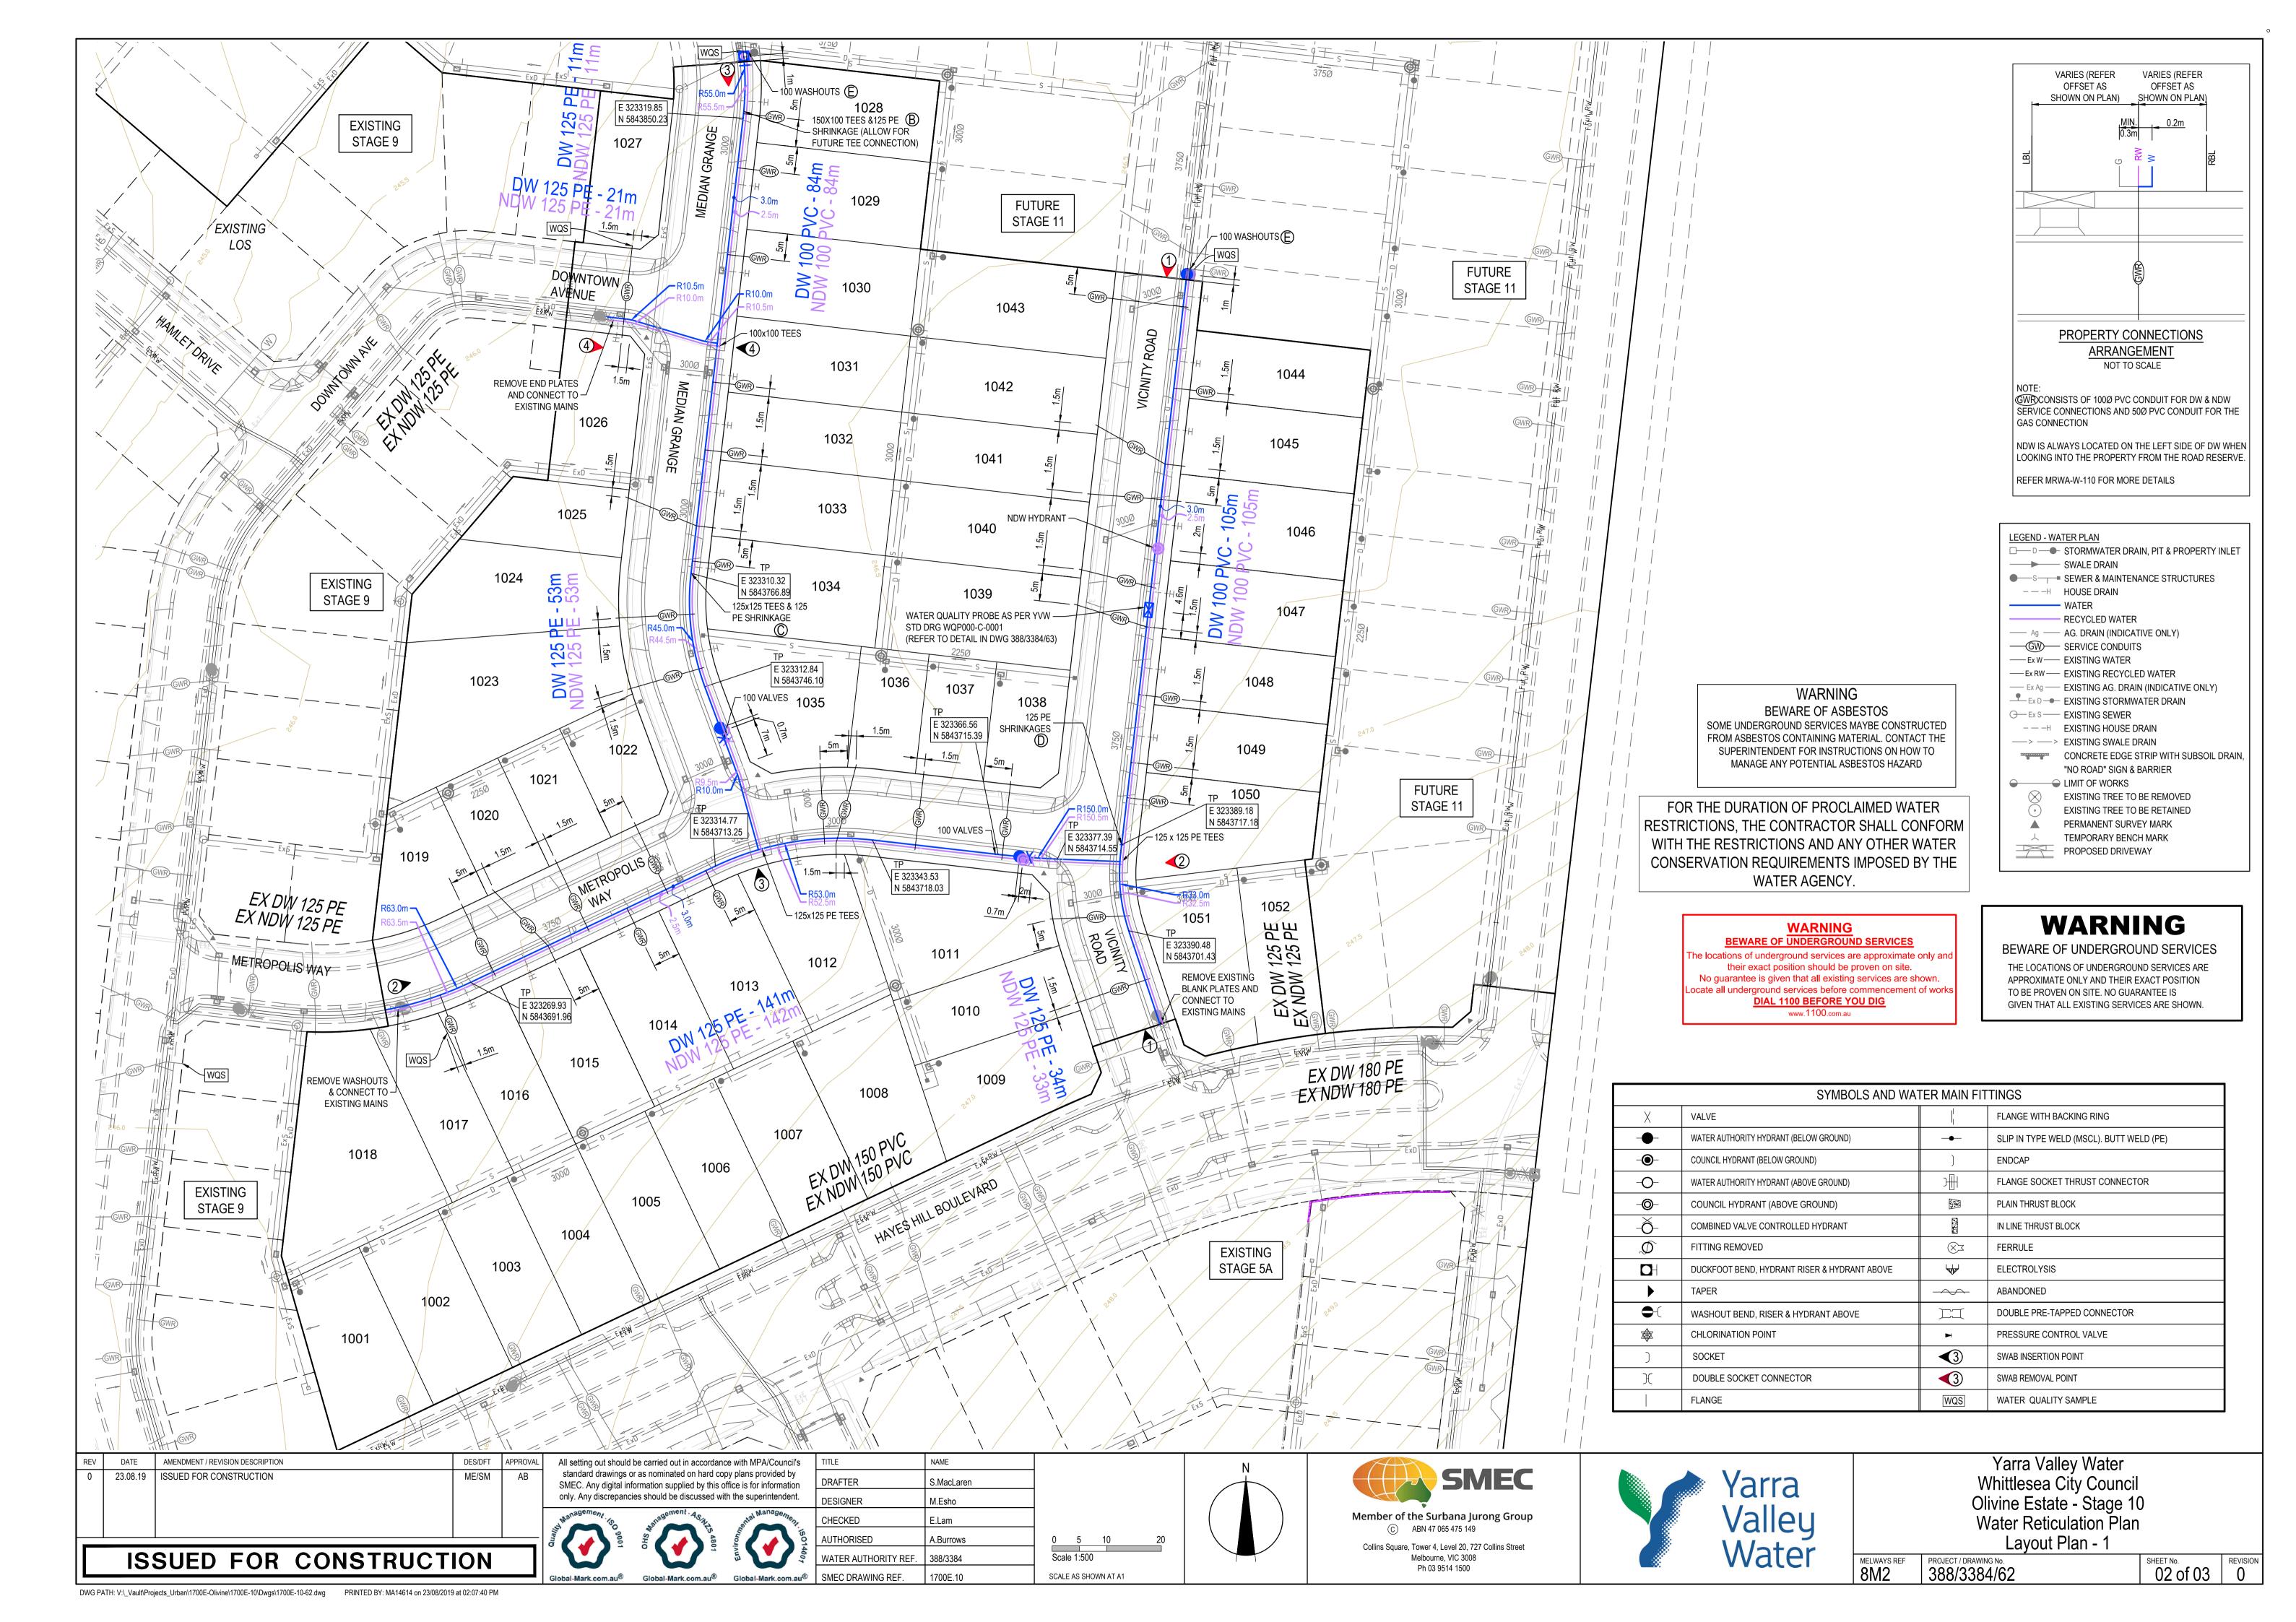



						POTENTIAL ELIMINATION MEASURE.			Residual [[]	Residual	Dasidual	
PHASE DISC	CIPLINE COI	<i>)</i>	iction- Operations- Maintenance ENTIAL RISK	RISK OWNER	POTENTIAL CONSEQUENCES	DESIGN INITIATIVE or CONTROL (Identify any Standard or Code of practice used)	HOW ISSUE ADDRESED IN DESIGN AND/OR CONSTRUCTION OF THE WORKS	IS THE RISK ELIMINATED YES/NO	Risk	Risk Consequ ence (0-5)	Residual Risk Rating	RESIDUAL RISK OWNER
		Road Furniture / Roadside features										i
Construction RD	#N/A	Construction close to live traffic	New works will be constructed adjacent to live traffic when abutting existing stages.	Contractor	Disruptions to live traffic, construction incident involving live traffic.	Provide safe temporary traffic control (TCP)	TCP provided within contract	N	5	3	15	Constructor
Construction RD	#N/A	Culverts	Potential risk from culverts under construction and height / fall hazards	Contractor	Falling from a height	Temporary barriers to be provided	Temporary barrier provided in contract	N	2	5	10	Constructor
Construction US	#N/A	Utilities become a hazard within clear zones	Vehicle conflict with utility / pit	Contractor	Personal injury, vehicle damage	Sequence works and protect with temp barrier or traffic control (TCP)	TCP provided within contract	N	1	5	5	Constructor
Operational RD	#N/A	Sight Lines	Inadequate drivers response time.	Road Authority	Increased potential for accidents	Ensure design complies with relevant standard. Undertake thorough Safety Audit	Vis lines checked and discussed with approval authority as part of design approval process	N	1	4	4	Road Authority
Operational LS	#N/A	Signs and street lights	Potential for drivers / riders to strike signs and street lights	Road Authority	Increased potential for accidents	Ensure design complies with relevant standard. Undertake thorough Safety Audit	Refer to appropriate standard for sign and lighting offsets	s N	1	4	4	Road Authority
Operational RF	#N/A	Headwalls	Potential vehicle conflict within clear zone	Road Authority	Increased potential for accidents	Establish adequate clear zone provision	Adequate barrier provided as per appropriate standard where within clear zone. Culvert headwall selection in accordance with authority standard	N	2	4	8	Road Authority
Operational RD	#N/A	Culverts	Potential fall hazard during maintenance, by vechicles and pedestrians	Relevant Authority	Falling from a height	Barriers to be provided in accordance with road standards	Barriers to be provided and safe batter slopes (>1:3)	N	2	5	10	Constructor
		Retaining Walls										ì
Construction RW	#N/A	Retaining Wall Alignment	Falling from height during construction or commissioning of walls and adjacent structures eg. sewer manholes	Contractor	Falling from a height	Provide temporary and permanent fencing at top of wall.	Provide fencing (at heights) during design process	N	1	1	1	Constructor
Operational RW	#N/A	Retaining Wall Alignment	Lack of safe access/setback from road	Road/ Local Authority	Increased potential for accidents	Establish adequate and accessible clear zone provision. Provide guardrail where required	Wall located in suitable position during design process and approved by authority	N	1	1	1	Authority
Operational RW	#N/A	Retaining Wall Height	Potential for falling from height	Road/ Local Authority	Personal injury	Provide temporary and permanent fencing at top of wall.	Provide fencing (at heights) during design process	N	1	5	5	Authority
Operational RW	#N/A	Retaining Wall Design	Potential for wall failure	Road/ Local Authority	Increased potential for accidents	Structural design in accordance with standards, geotechnical conditions, end use and good practise.	Refer to structural drawings and calculations	N	1	5	5	Authority
		Drainage										
Operational DR	#N/A	Grated Pits	Trip/fall hazard with large spaced grate	Relevant Authority	Increased potential for accidents	Provide pedestrian/bicycle friendly grates where applicable. Refer to pit schedule	Design in accordance with authority and manufacturers standards	N	3	2	6	Authority
Operational DR	#N/A	Non Standard Large Pits	Potential for pit failure	Relevant Authority	Increased risk to maintenance crews/ vehicles	Structural design in accordance with relevant design principles.	Refer to structural drawings and calculations	N	1	4	4	Authority
Operational DR	#N/A	Culvert Endwalls/Headwalls	Potential for falling from height	Relevant Authority	Increased potential for accidents	Fencing to be provided where culverts/headwalls are at height in accordance with relevant authority standards	Allow for fencing in Design Process	N	1	4	4	Authority
Operational DR	#N/A	Culvert Endwall/Headwall Outlets	Children playing in large pipes / watercourses and access for maintenance	Relevant Authority	Increased potential for accidents	Grate provided to authority standards	Design in accordance with authority and manufacturers standards	N	2	5	10	Authority
Maintenance DR	#N/A	Access to Pits	Lack of safe access for maintenance	Relevant Authority	Increased risk to maintenance crews	Provide safe working conditions for maintenance. Provide safe landing/ access arrangements as per relevant authority standards	Where possible design pit in location for easy access and outside of permanent water bodies	N N	2	5	10	Authority
Maintenance DR	#N/A	Deep Pits	Lack of safe entry for maintenance	Relevant Authority	Increased potential for accidents	Contractor to be certified for work in confined spaces, step irons to be provided to appropriate authority standards. Refer to pit schedule	Design in accordance with authority standards	N	1	5	5	Authority
Maintenance DR	#N/A	Access to drains / culverts	Lack of safe access for maintenance	Relevant Authority	Increased risk to maintenance crews	Provide safe working conditions for maintenance. Access as approved by authority	Design pit in location for easy access as agreed with authority	N	2	3	6	
		Sewer										i
Construction SE	#N/A	Sewer Manhole located adjacent to Retaining Wall Alignment	Falling from height during construction or commissioning of adjacent sewer manholes	Contractor	Falling from a height	Provide temporary fencing until such time that permanent fencing is constructed	Provide fencing (at heights) during design process	N	1	1	1	Constructor
Maintenance SE	#N/A	Deep Manholes	Lack of safe entry for maintenance	Relevant Authority	Increased potential for accidents	Contractor to be certified for work in confined spaces, landings and step access provided as per authority standards and schedule	Design in accordance with authority standards. Refer pit schedule on drawings	N	1	5	5	Authority
Maintenance SE	#N/A	Access to Manholes	Lack of safe access for maintenance	Relevant Authority	Increased risk to maintenance crews	Provide safe working conditions for maintenance. Manholes located in compliance with authority standards	Where possible design manhole in location for easy access	N	1	5	5	Authority
Maintenance SE	#N/A	Pump Station Access	Lack of safe access for maintenance	Relevant Authority	Increased risk to maintenance crews	Provide safe working conditions for maintenance	Design pump station in location for easy access	N	2	4	8	Authority
		Electricity										
Operational ES	#N/A	Electrical Design	Location of assets within clear zones e.g., pits/ substations	Relevant Authority	Increased potential for accidents	Electrical designed by sub consultant with appropriate accreditation and in accordance with authority standards	Pits designed below ground. Where above ground adequate offset from vehicle clear zones has been provided or barrier protection provided	N	2	3	6	Authority
		Telstra					, , , , , , , , , , , , , , , , , , , ,					
Operational TE	#N/A	Telstra Design	Location of assets within clear zones e.g., pits	Relevant Authority	Increased potential for accidents	Telecommunications designed by authority consultant with appropriate accreditation and in accordance with authority standards	Pits designed below ground. Where above ground adequate offset from vehicle clear zones has been provided or barrier protection provided	N	2	3	6	Authority
		Water				Standards	p.ortidod of Sairior protection provided					
Operational WA	#N/A	Water Design	Location of assets within clear zones e.g., pits/ substations	Relevant Authority	Increased potential for accidents	Water pits designed in accordance with authority standards	Pits designed below ground. Where above ground adequate offset from vehicle clear zones has been provided or barrier protection provided	N	2	3	6	Authority
		Gas					p. strada di paritoi protodiori provided					
Operational GA	#N/A	Gas Design	Location of assets within clear zones e.g., pits/ substations	Relevant Authority	Increased potential for accidents	Water pits designed in accordance with authority standards	Pits designed below ground. Where above ground adequate offset from vehicle clear zones has been	N	1	1	1	Authority
							provided or barrier protection provided				0	

REV	DATE	AMENDMENT / REVISION DESCRIPTION	DES/DFT	APPROVAL	_
A	28.05.19	ISSUED TO COUNCIL FOR APPROVAL	SM/RB	AB	

All setting out should be carried out in accordance with MPA/Council's standard drawings or as nominated on hard copy plans provided by SMEC. Any digital information supplied by this office is for information only. Any discrepancies should be discussed with the superintendent.



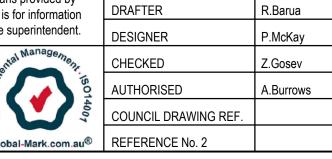

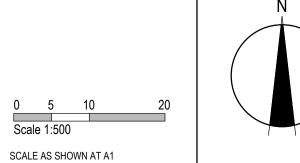





Olivine Estate - Stage 10
Whittlesea City Council
Road and Drainage
Safety In Design

